


TEE-0008-00(156) HALL COUNTY PI# 0008156


STA 0+34 ALLEN STREET

BEGIN PROJECT TEE 008-00(156)

State Project No. TEE-0008-00(156)

Sheet No. **Total Sheets** 

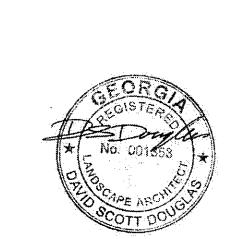

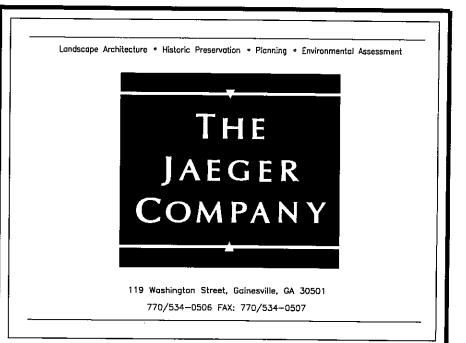

## PROJECT DIRECTORY

## **CONSULTANT TEAM**

THE JAEGER COMPANY LANDSCAPE ARCHITECTURE & PRESERVATION PLANNING 675 PULASKI ST, SUITE 1000 **ATHENS, GA 30601** SCOTT DOUGLAS, PROJECT MANAGER 706.553.5459 EXT. 225

**ROCHESTER & ASSOCIATES** LAND SURVEYING & ENGINEERING 425 OAK STREET, NW GAINESVILLE, GA 30501 **JOSH TRAWICK** 678.450.5126

## SPONSOR/OWNER

THE CITY OF OAKWOOD, GEORGIA 4035 WALNUT CIRCLE OAKWOOD, GA 30566 LARRY SPARKS, PLANNING DIRECTOR 770.534.2365

## **UTILITIES**

## **ELECTRICAL**

GEORGIA POWER COMPANY **426 SPRING STREET** GAINESVILLE, GA 30501 1-800-282-7411

## **WATER AND SEWER**

**PUBLIC UTILITIES DEPARTMENT** KELLY J. RANDALL, DIRECTOR PUBLIC UTILITIES ADMIN BUILDING 757 QUEEN CITY PARKWAY GAINESVILLE, GA 30501

## **TELEPHONE**

AT&T 325 JESSE JEWELL PKWY SE GAINESVILLE, GA 30501 770-536-2055

## CABLE-BROADBAND

CHARTER 3303 W. COMMERCIAL BLVD. FORT LAUDERDALE, FL 33309 1-877-256-2781

## **REVISION SUMMARY**

STA 7+13 MAIN STREET

END PROJECT TEE 008-00(156)

EVISION	DATE	DESCRIPTION
EV 1	1.31.08	GDOT COMMENTS
7		
<u> </u>		<u> </u>

PROJECT LOCATION MAP **PROJECT** BEGINNING OF MCCLURE DR. NOTE: ENTIRE PROJECT AREA FALLS WITHIN HALL COUNTY

## INDEX OF DRAWINGS

SHEET TITLE

**COVER SHEET EXISTING CONDITIONS** L.101

**DEMOLITION PLAN** L.201 L.301 LAYOUT PLAN

L.401 PLANTING PLAN L.402 **DETAILS** 

L.501 SIGNING AND MARKING PLAN

L.601 IRRIGATION PLAN

EROSION AND SEDIMENT CONTROL PLAN **EROSION AND SEDIMENT CONTROL NOTES & DETAILS** 

STREET

C. 01 GRADING AND DRAINAGE

C. 02 A STORM PROFILE

STORM PROFILE

# PROJECT LENGTH AND DISTURBED AREA

PROJECT LENGTH: 0.13 MILES (677 FEET)


TOTAL DISTURBED AREA: .92 ACRES

NOI IS NOT REQUIRED FOR THIS PROJECT

NOTE: THIS PROJECT WILL BE BID AS LUMP SUM CONSTRUCTION

RAILROAD STREET 13

All work shall conform to "GDOT Standard Specifications - 2001 Edition", as approved by the Federal Highway Administration and as modified by the contract documents.

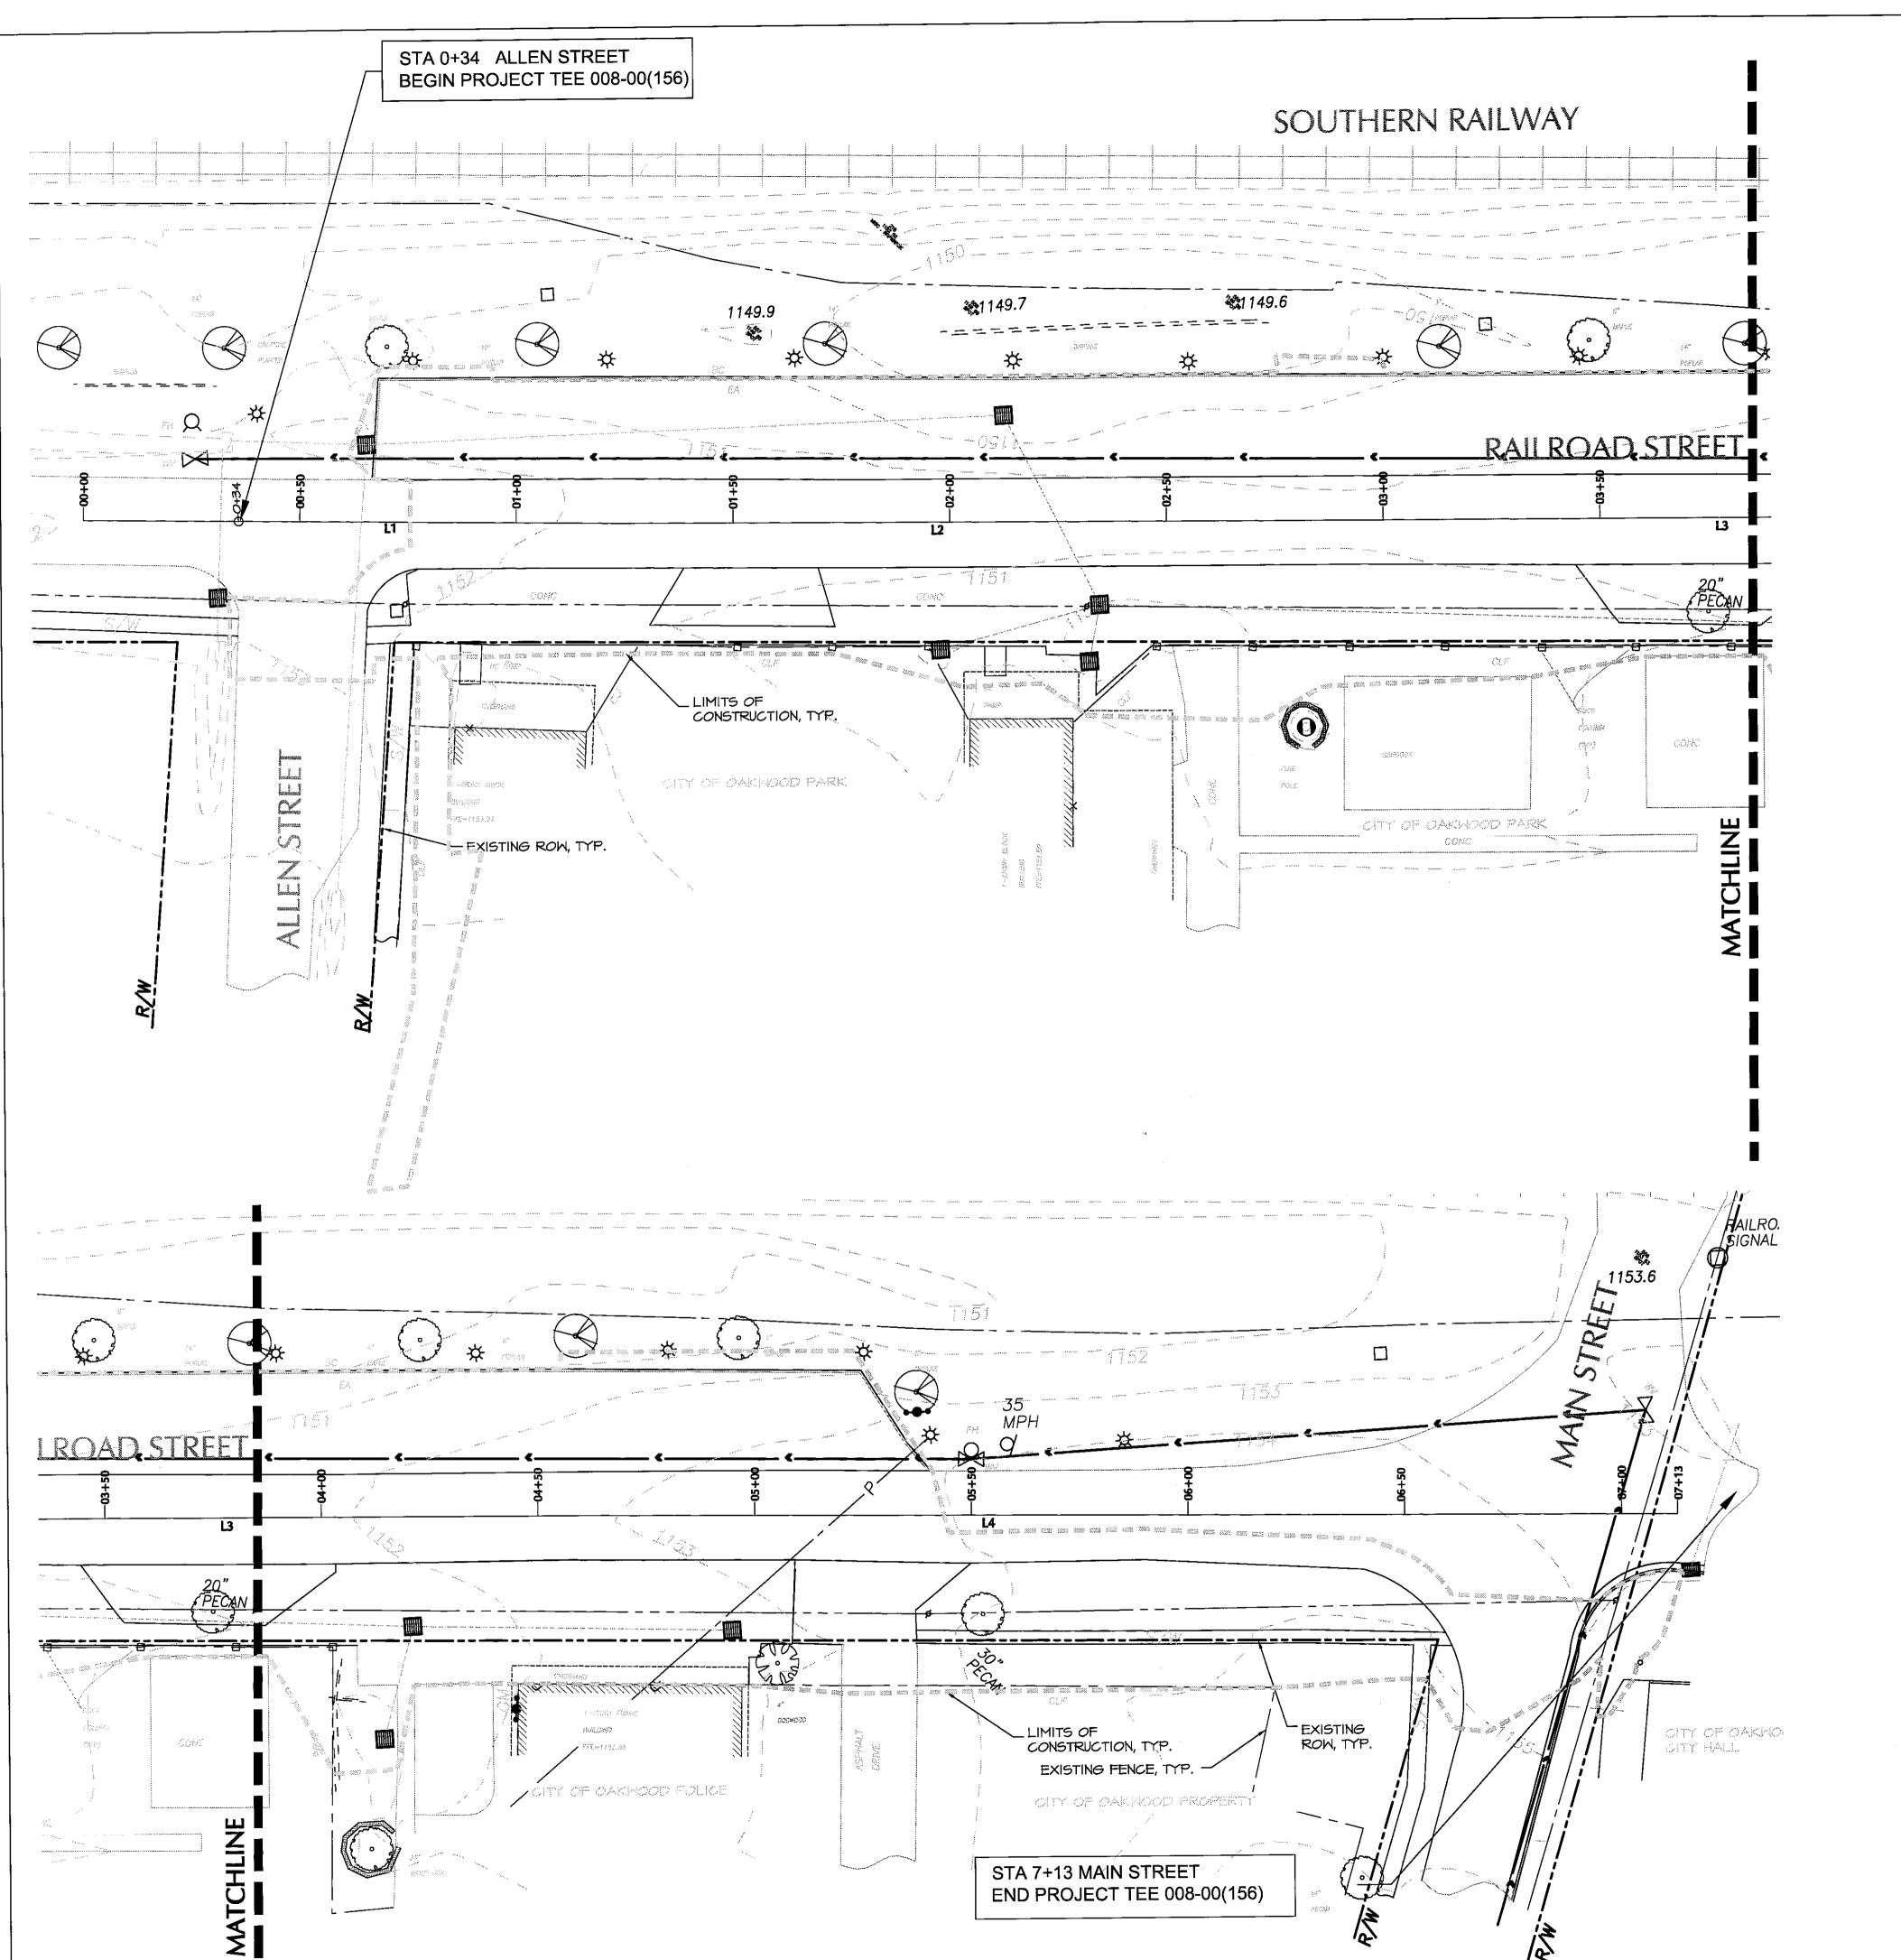

HALL<br/>COUNTYCONSTRUCTION ELEMENTSHEET<br/>NO.TOTAL<br/>SHEETSTEE-0008-00(156)213

## LEGEND

G	EXISTING INTERMEDIATE CONTOUR EXISTING INDEX CONTOUR WATER MAIN GAS LINE STORM DRAIN
<b>⊄</b> FH	FIRE HYDRANT
○ <i>M.H</i> .	MANHOLE
₩V	WATER VALVE
• GV	GAS VALVE
WM	WATER METER
□ TBX	TELEPHONE BOX
	FENCE
<b>D</b> PTP	POWER /TELEPHONE POLE
o IP	IRON PIN FOUND
111111 DI	DROP INLET
P	OVERHEAD POWER LINE
● JB	JUNCTION BOX
1 GW	GUY WIRE
	PROPERTY LINE
1	EDGE OF PAVEMENT
<del>\</del>	LIGHT POLE
$\odot$	EXISTING TREE

## GENERAL NOTES

- THE CONTRACTOR SHALL PROVIDE SAFE PEDESTRIAN INGRESS/EGRESS USING TEMPORARY WALKS AND RAMPS AS NECESSARY TO ALL BUSINESSES DURING CONSTRUCTION AND SHALL NOTIFY BUSINESS OWNERS 48 HOURS PRIOR TO DISTURBANCE ADJACENT TO THEIR PROPERTY.
- 2. THE CONTRACTOR WILL BE RESPONSIBLE FOR ALL DAMAGE CLAIMS REGARDING AWNINGS OR OTHER PROPERTY WITHIN THE RIGHT OF WAY.
- 3. THE CONTRACTOR WILL BE RESPONSIBLE FOR PREPARING A TRAFFIC CONTROL PLAN SHOWING THE PROPOSED MEASURES TO MANAGE TRAFFIC DURING CONSTRUCTION ACTIVITIES. THE PLAN SHALL CONFORM TO THE 2003 MANUAL OF UNIFORM TRAFFIC DEVICES AND GEORGIA DOT SPECIFICATION 150. ANY LANE CLOSURES MUST BE APPROVED BY AND COORDINATED WITH THE GDOT AREA ENGINEER. LANE CLOSURES WILL REQUIRE PROPER LANE TAPERS AND ADVANCE WARNINGS PER GEORGIA DOT STANDARDS.
- 4. SHOULD AN UNDERGROUND TANK BE ENCOUNTERED DURING CONSTRUCTION THE CONTRACTOR SHALL IMMEDIATELY STOP WORK IN THAT AREA AND CONTACT THE GEORGIA ENVIRONMENTAL FACILITIES AUTHORITY, 100 PEACHTREE STREET NW, ATLANTA, GA. AT (404) 657-1322.
- 5. UTILITIES MUST BE FIELD LOCATED BEFORE CONSTRUCTION; PRIOR TO PERFORMING ANY LAND DISTURBANCE ACTIVITIES OR WHEN WORK IS TO BE PERFORMED WITHIN TEN FEET OF HIGH VOLTAGE OVERHEAD POWER LINES, THE CONTRACTOR IS REQUIRED BY LAW TO NOTIFY THE UTILITY PROTECTION CENTER AT 1-800-282-7411; SEVENTY-TWO HOUR ADVANCE NOTICE IS REQUIRED.
- 6. THE CONTRACTOR SHALL NOT BE ALLOWED TO STORE OR STOCKPILE MATERIALS OR EQUIPMENT ON COUNTY OR STATE RIGHT-OF-WAY UNLESS PRIOR WRITTEN APPROVAL IS OBTAINED FROM THE RESPECTIVE JURISDICTION.
- 7. ALL SIGNING, MARKING, AND TRAFFIC CONTROL SHALL CONFORM TO THE MANUAL ON UNIFORM TRAFFIC CONTROL DEVICES, 2003 EDITION.
- 8. THIS PROJECT HAS BEEN DESIGNED TO COMPLY WITH THE TITLE II PROVISIONS OF THE AMERICAN WITH DISABILITIES ACT (ADA).



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119 Washington Street, Gainesville, GA 30501 770/534-0506 FAX: 770/534-0507


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RAILROAD STREET CORRIDOR IMPROVEMENT PROJECT PHASE I EE-0008-00(156); PI No. 0008156


ITY OF OAKWOOD L COUNTY, GEORGIA

Date:	1.31.08
Revisions	S:
ProjectNo	
Scale:	1" = 20



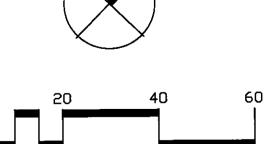

**CONDITIONS** 

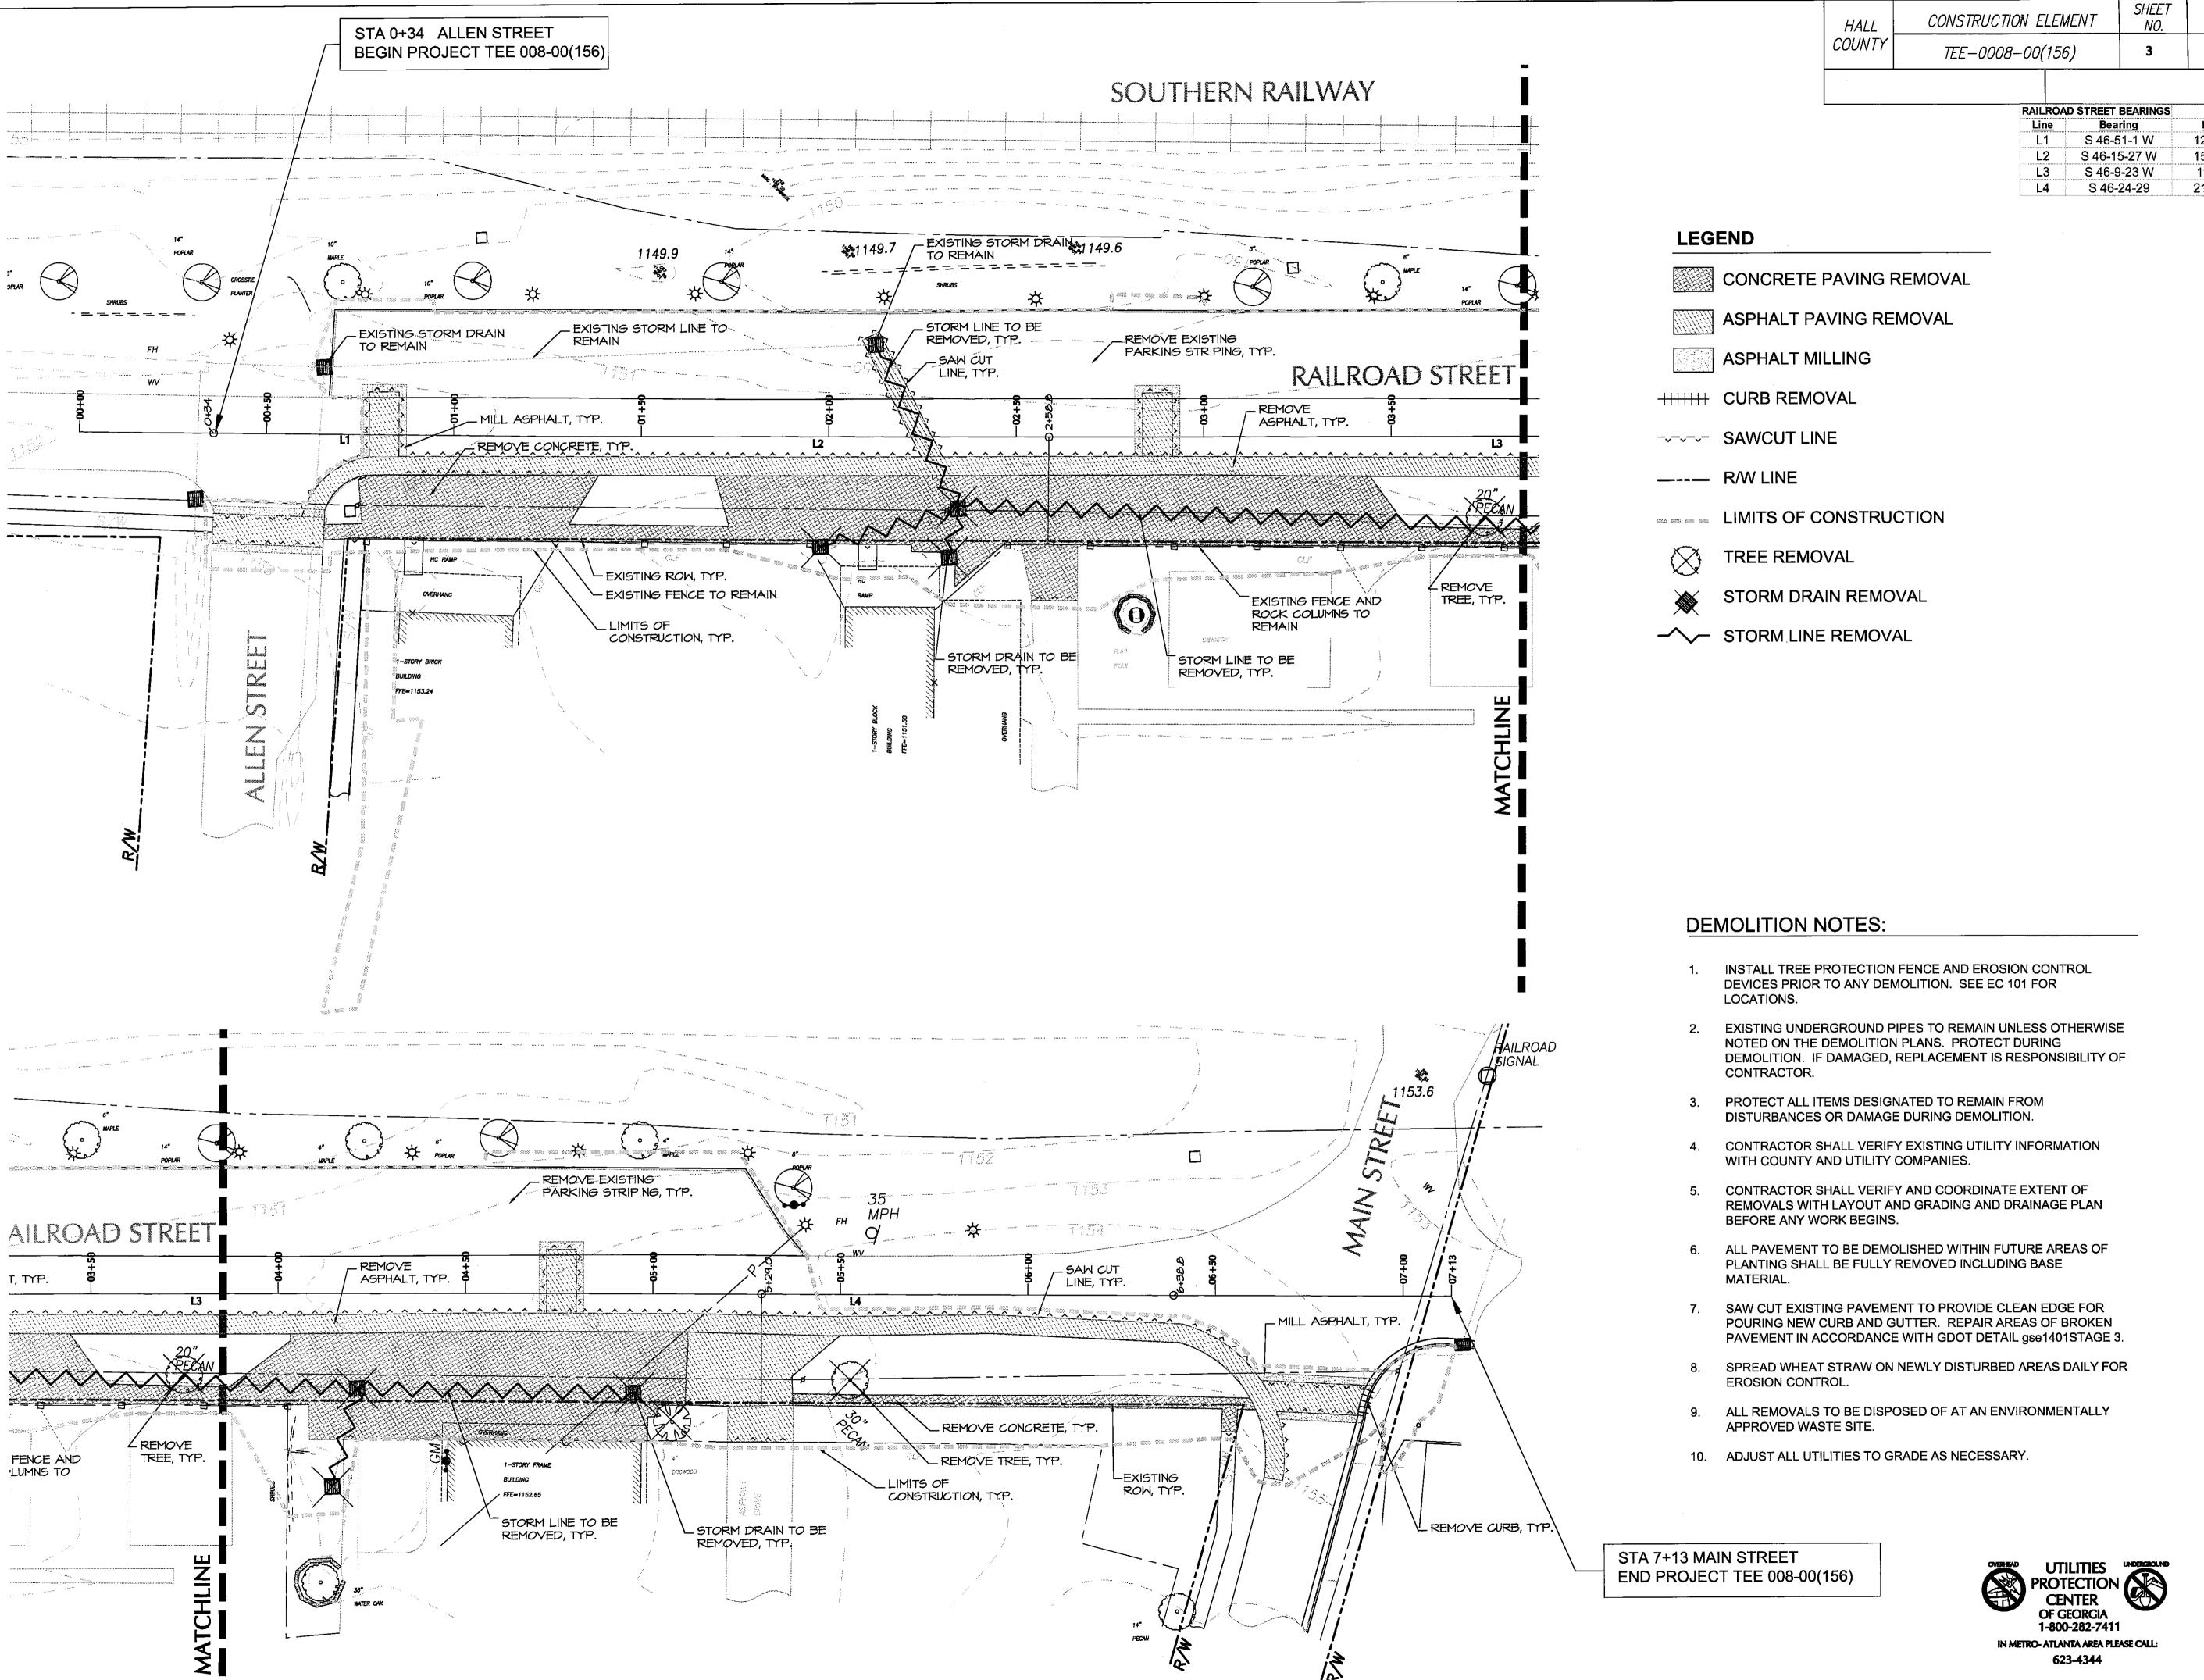

SHEETS

<u>Length</u> 124.2413 150.7214 191.571 219.4128



770/534-0506 FAX: 770/534-0507

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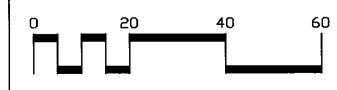
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Date: **1.31.08** 


ProjectNo.: **07002** Scale: \_\_\_\_\_\_**1" = 20**"

Drawn: **CP** Checked: SD,CT





**DEMOLITION PLAN** 

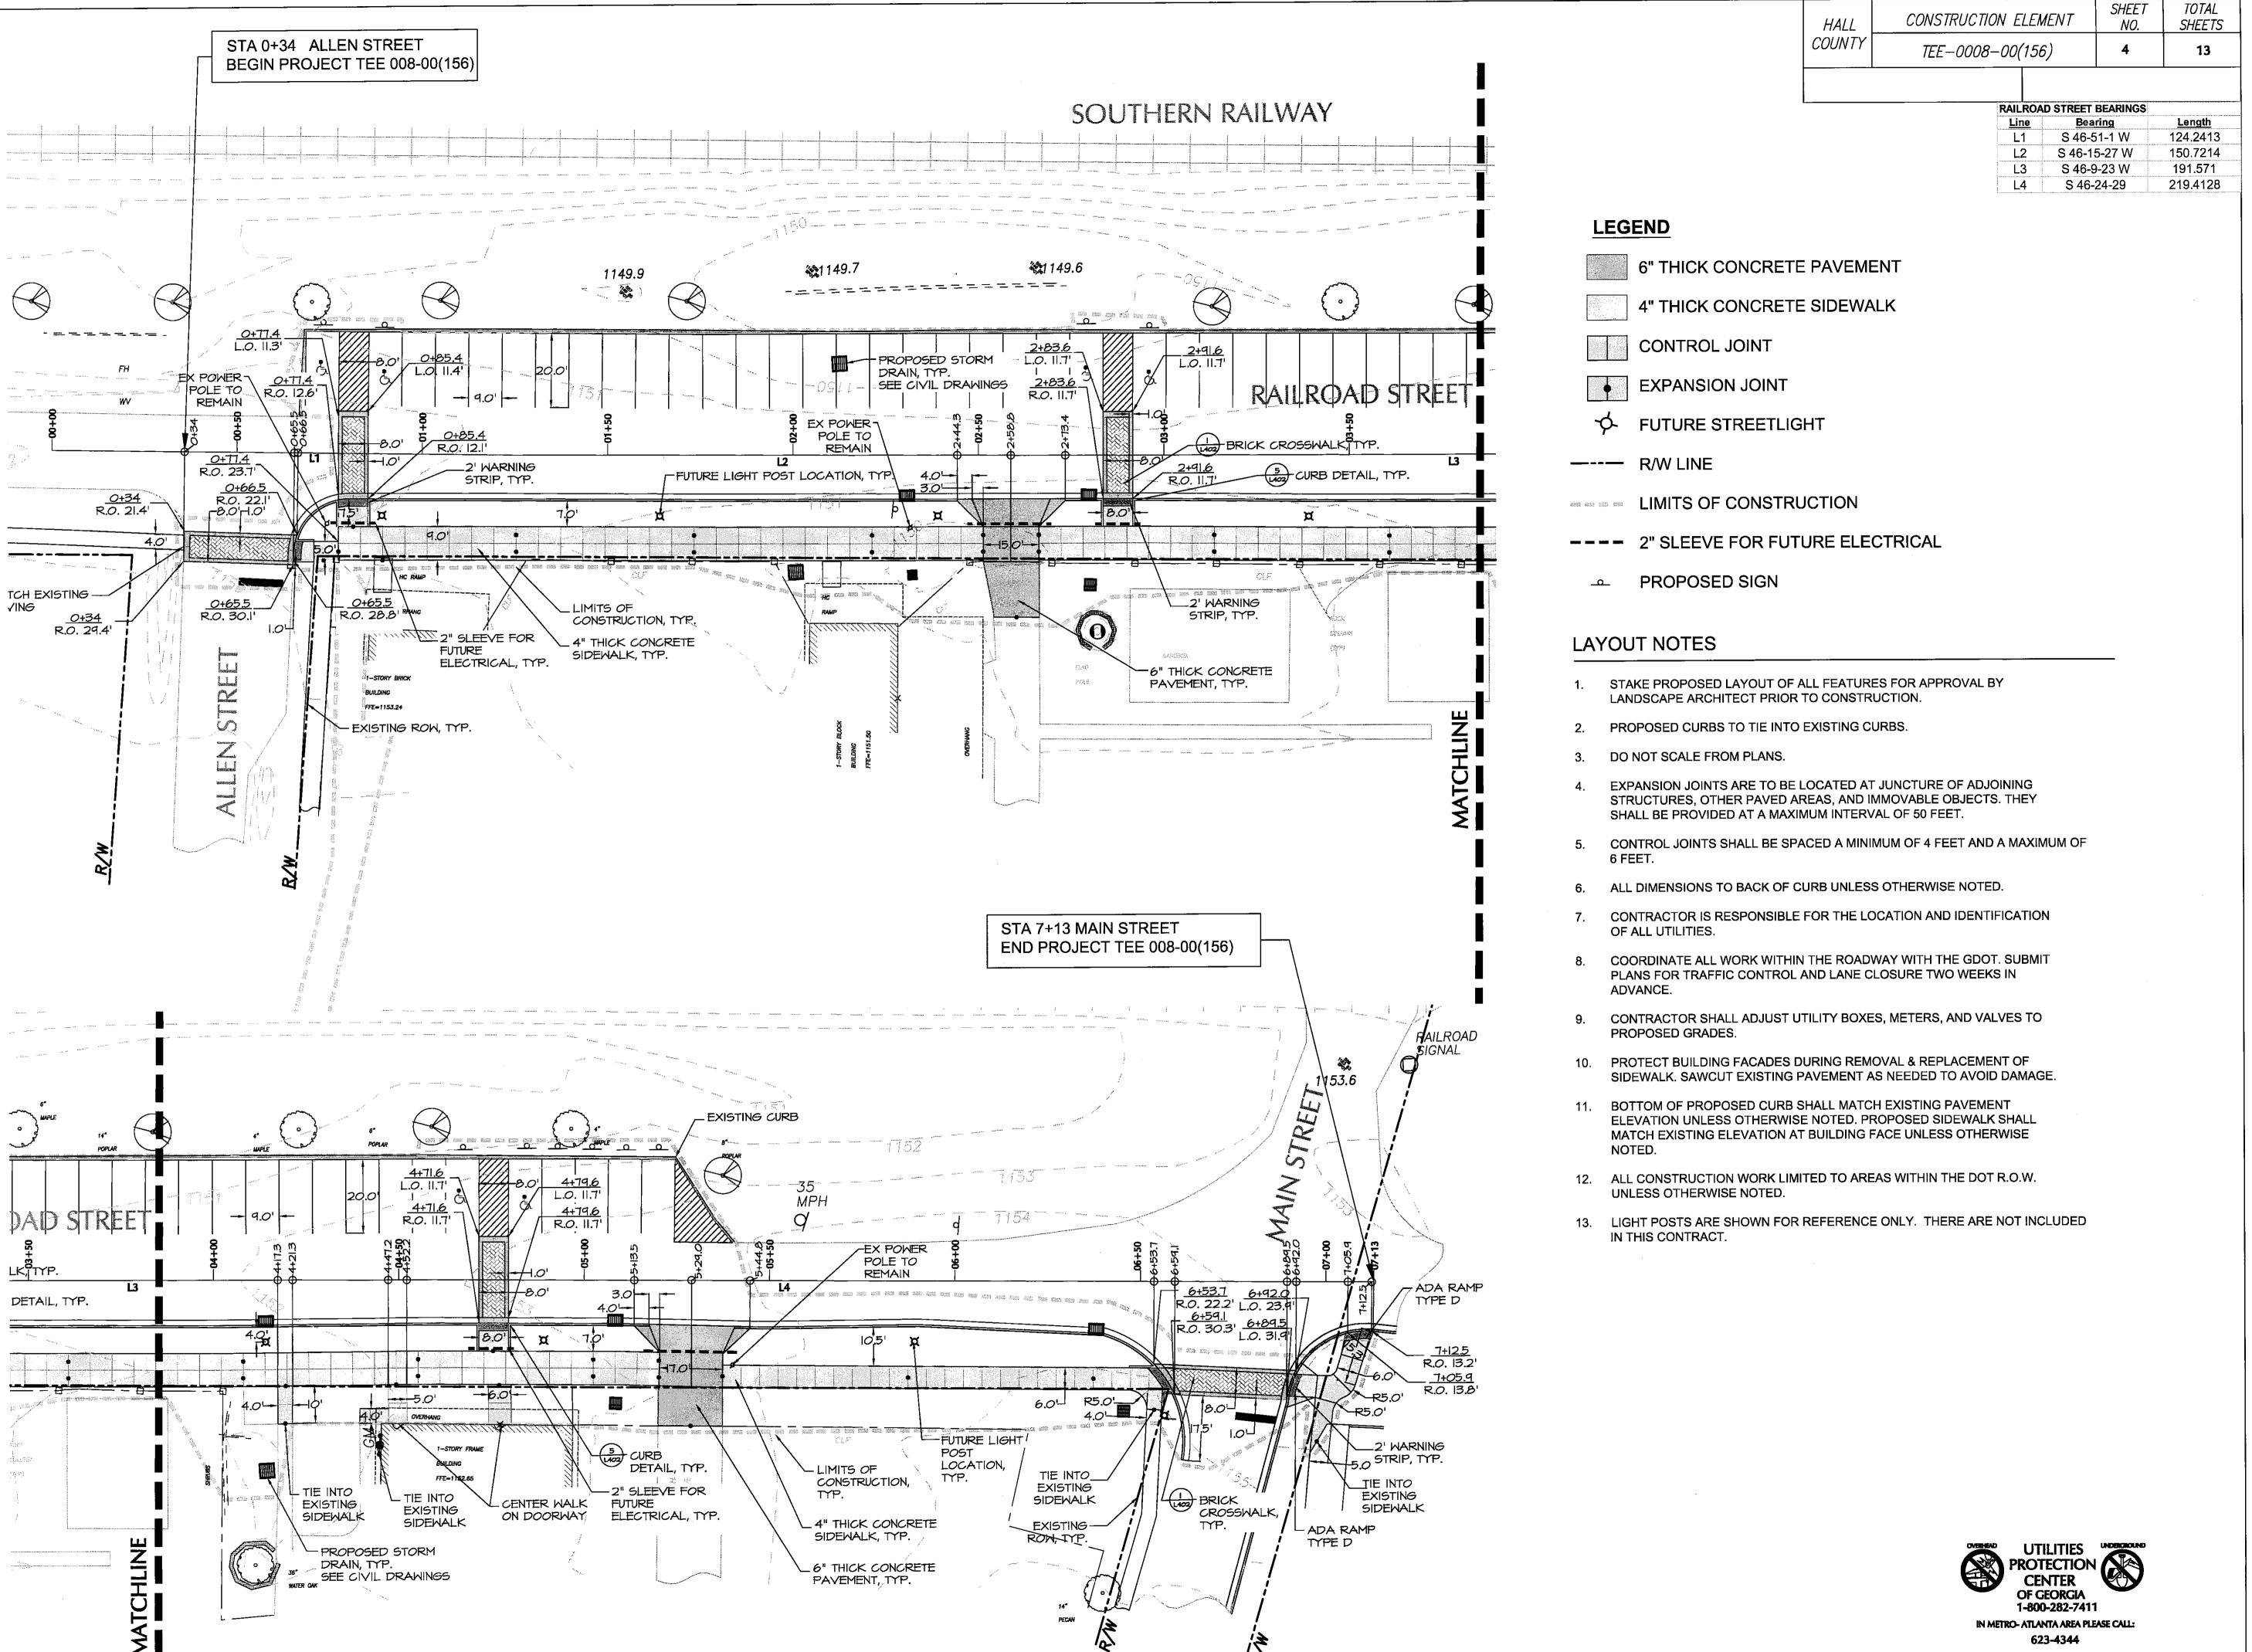

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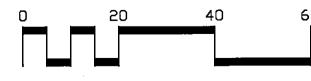
RAILROAD STREET CORRIDOR IMPROVEMENT PROJECT PHASE I 'EE-0008-00(156); PI No. 000815

Date:	1.31.08
Revisions:	


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Drawn: **CP** Checked: **SD,C**T





LAYOUT PLAN

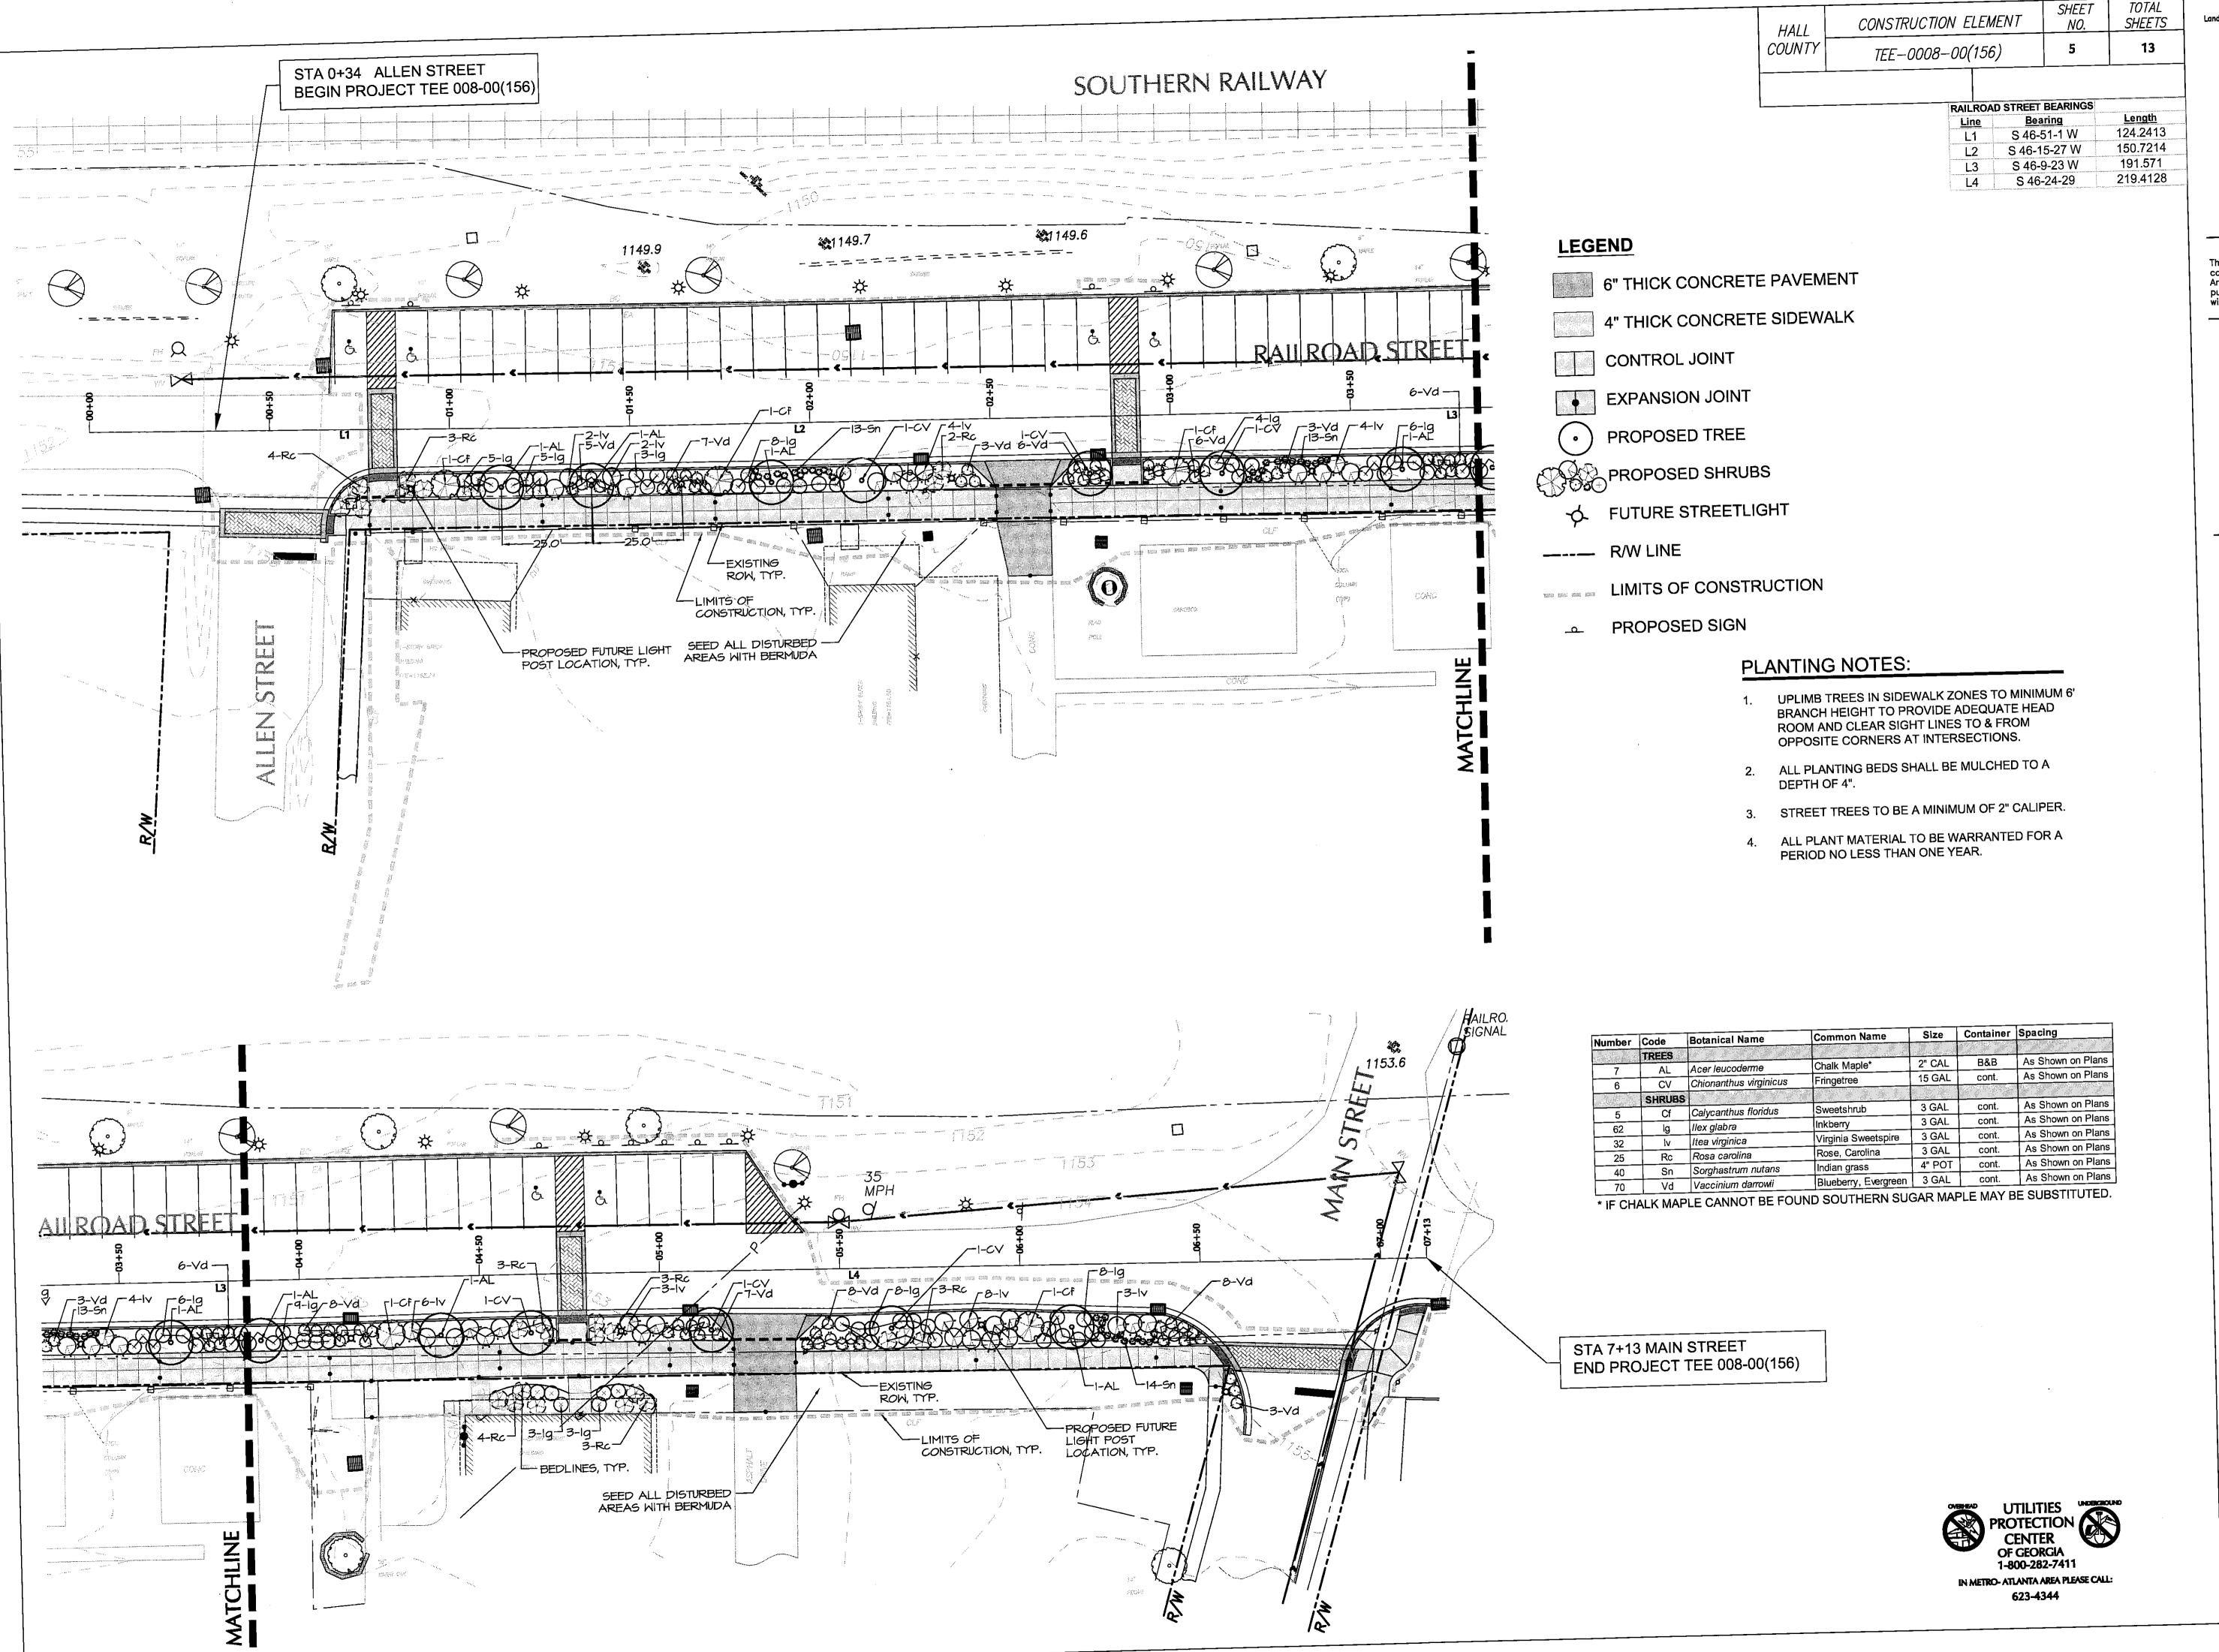

TOTAL
SHEETS
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CITY OF OAKWOOD


LL COUNTY, GEORGI/

Date: 1.31.08

Revisions:


ProjectNo.: <u>07002</u> Scale: \_\_\_\_\_1" = 20

Drawn: **CP** Checked: **SD,CT** 

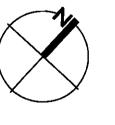

20 40

PLANTING PLAN

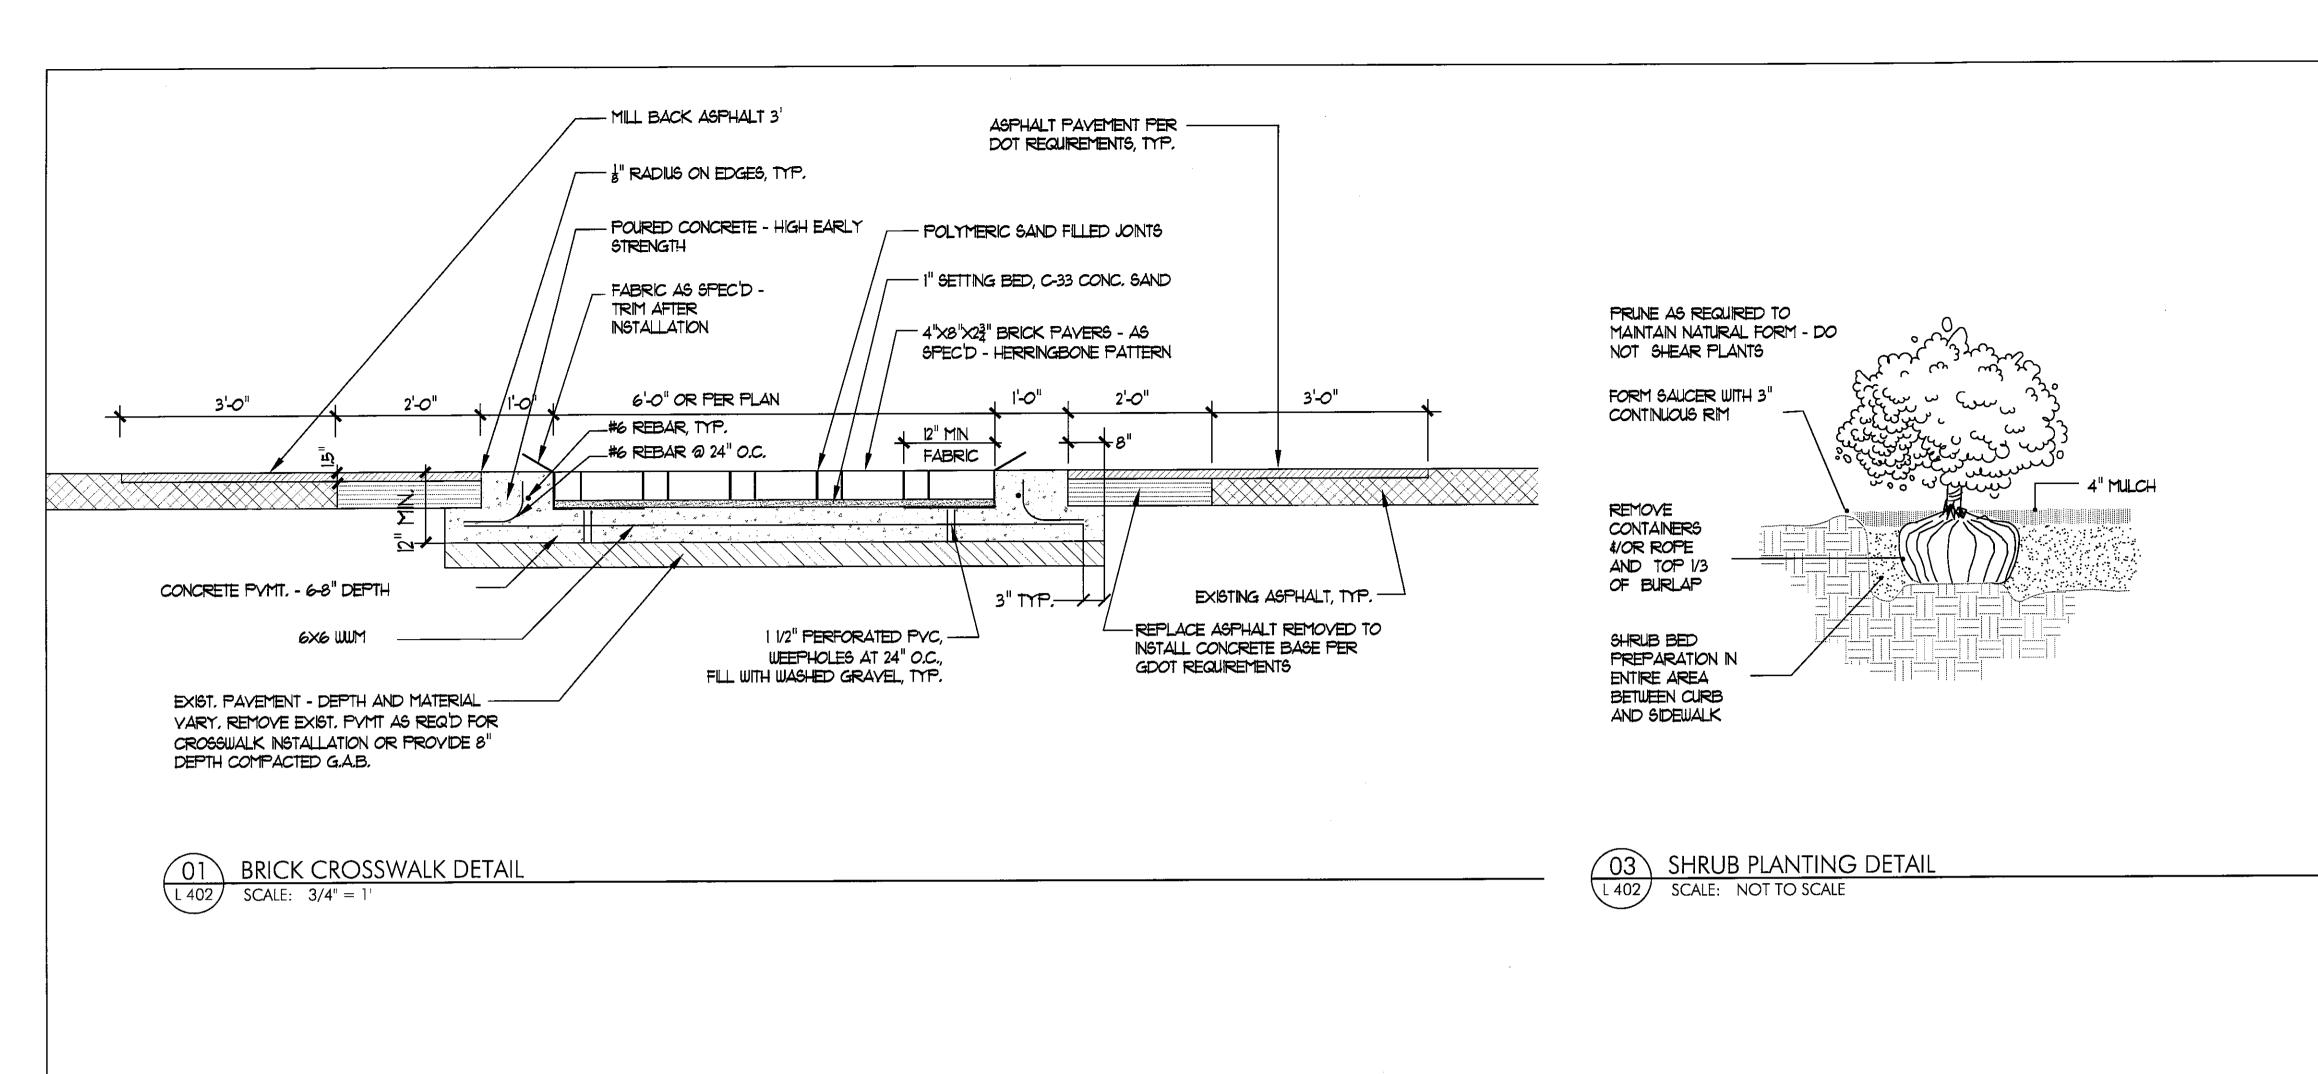



HALL	CONSTRUCTION ELEMENT	SHEET NO.	TOTAL SHEETS
COUNTY	TEE-0008-00(156)	6	13

SEE GOOT STANDARD DETAILS FOR SIDEWALK AND WHEELCHAIR RAMPS, CURB AND GUTTER, DRIVEWAY APRONS, AND STRIPING


GO TO http://tomcat2.dot.state.gaus/stds\_dtls/ TO DOWNLOAD THE CURRENT EDITION OF THESE GDOT DETAILS:

GDOT STANDARD DETAIL			
NUMBER	NAME	DATE REVISED	
A1	DRIVEWAYS WITH TAPERED ENTRANCES, CONCRETE VALLEY GUTTERS	APRIL 11, 2002	
A3	CONCRETE SIDEWALK DETAILS, CURB CUT (WHEELCHAIR) RAMPS	MAY 2006	
A4	DETECTABLE WARNING SURFACE, TRUNCATED DOME SIZE, SPACING AND ALIGNMENT REQUIREMENTS	MAY 2006	
T14	DETAILS OF PAVEMENT MARKING HATCHING	JAN. 2000	
1019A	STANDARD PRECAST DROP INLETS	AUG. 1999	
9032B	CONCRETE CURB AND GUTTER, CONCRETE CURBS, CONCRETE MEDIANS	MARCH 2003	
T-11A	DETAILS OF PAVEMENT MARKING PLACEMENT NON—LIMITED ACCESS ROADWAY	JAN. 2000	
T-18	DETAILS OF HANDICAPPED PAVEMENT MARKINGS	JAN. 2000	

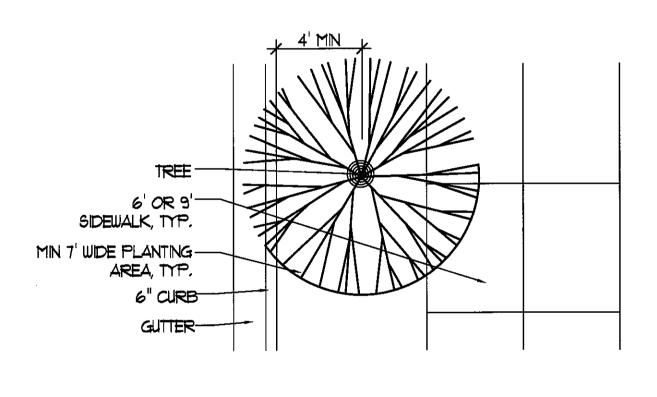

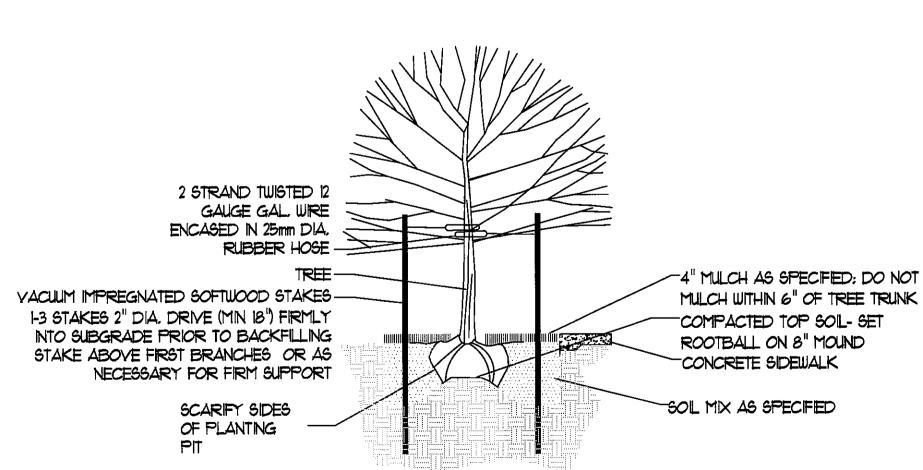


02 TREE PLANTING DETAIL
L 402 SCALE: NOT TO SCALE

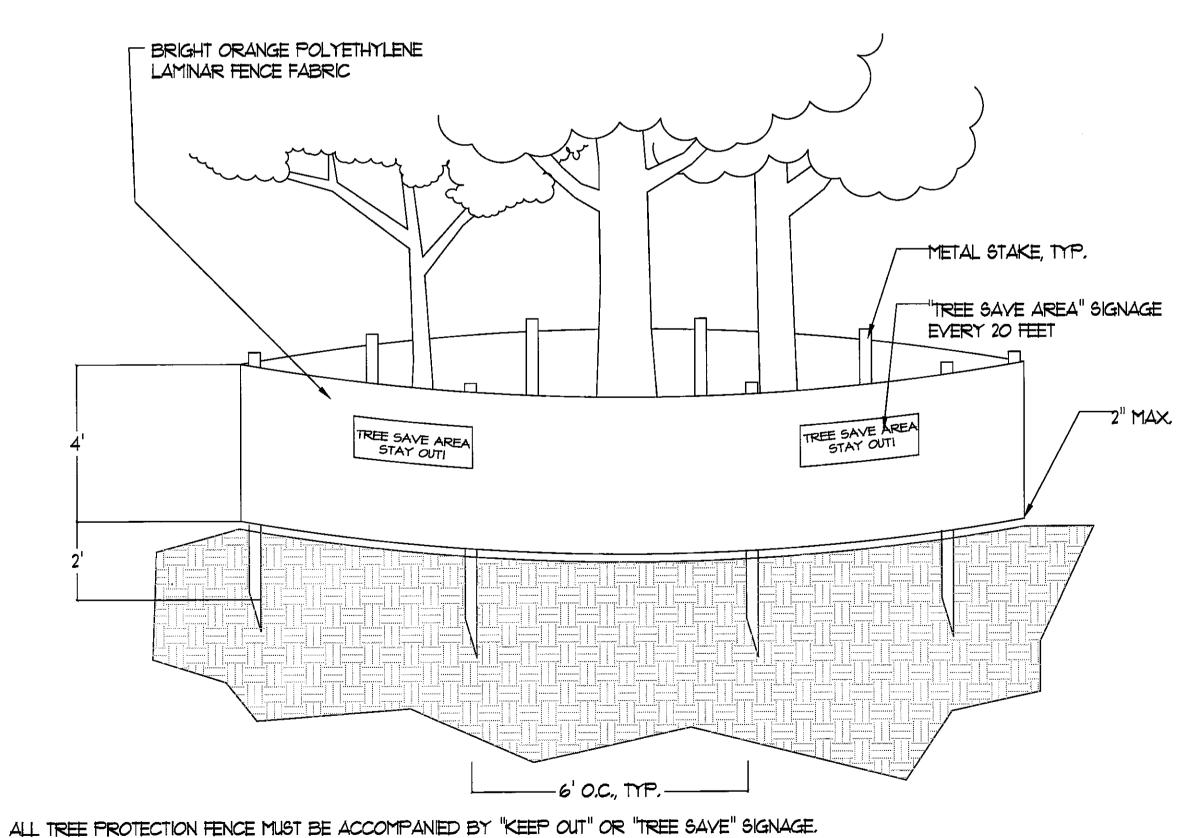

THEFT ROTECTION FERGE THAT DE ACCOM ANIES DE TREE CON ON THEE

1 TREE PROTECTION FENCE DETAIL SCALE: NOT TO SCALE

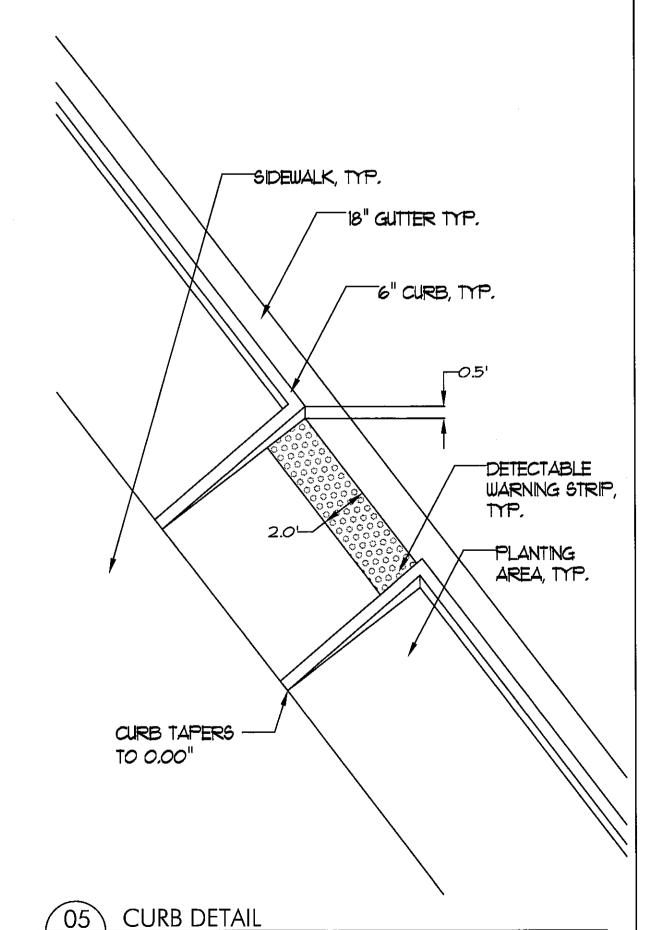


L 402 SCALE: NOT TO SCALE

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IMPROVEMENT PROJECT
PHASE I
EE-0008-00(156); PI No. 0008156

Date: 1.31.08


Revisions: \_\_\_\_\_\_

ProjectNo.: 07002

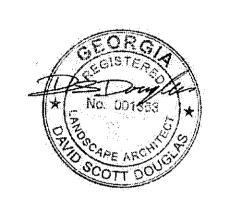Scale: \_\_\_\_\_

Checked: **SD,CT** 

**DETAILS** 

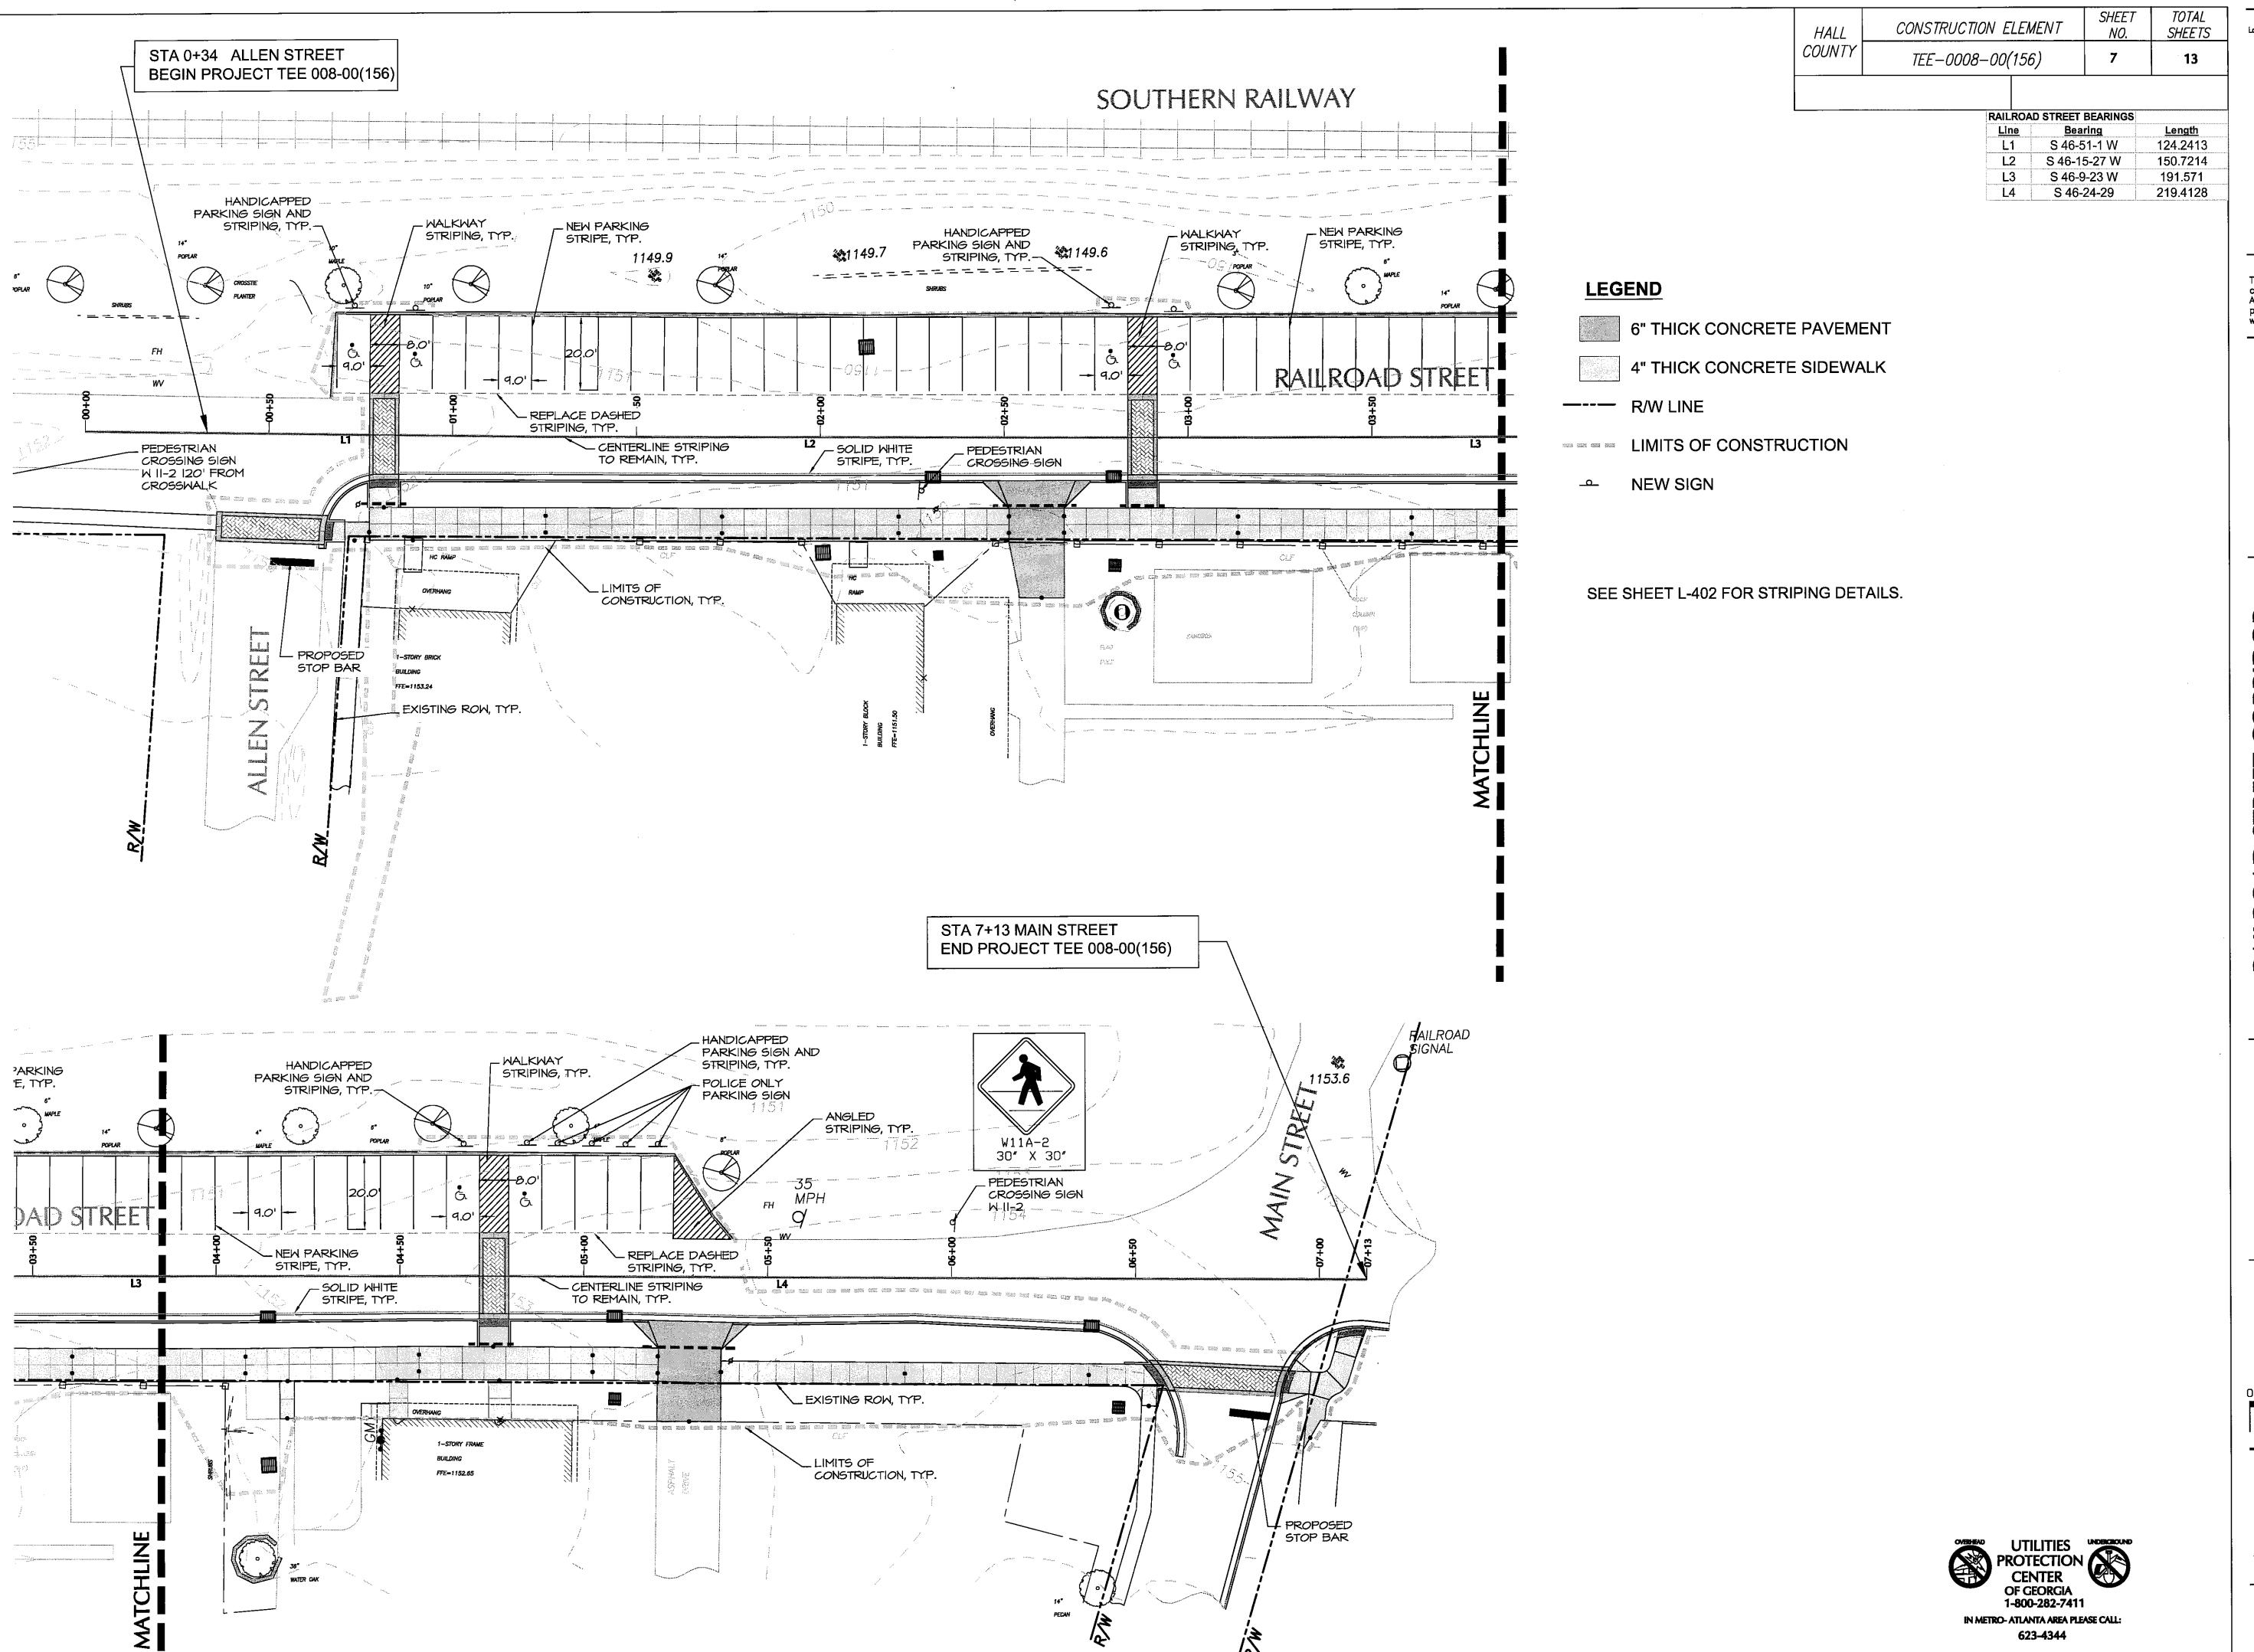

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Date: 1.31.08


Revisions: \_\_\_\_\_\_

HALL


ProjectNo.: <u>07002</u> Scale: <u>1" = 20'</u>

Drawn: **CP** Checked: **SD,CT** 



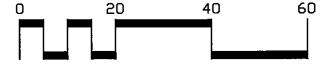

SIGNING AND MARKING PLAN

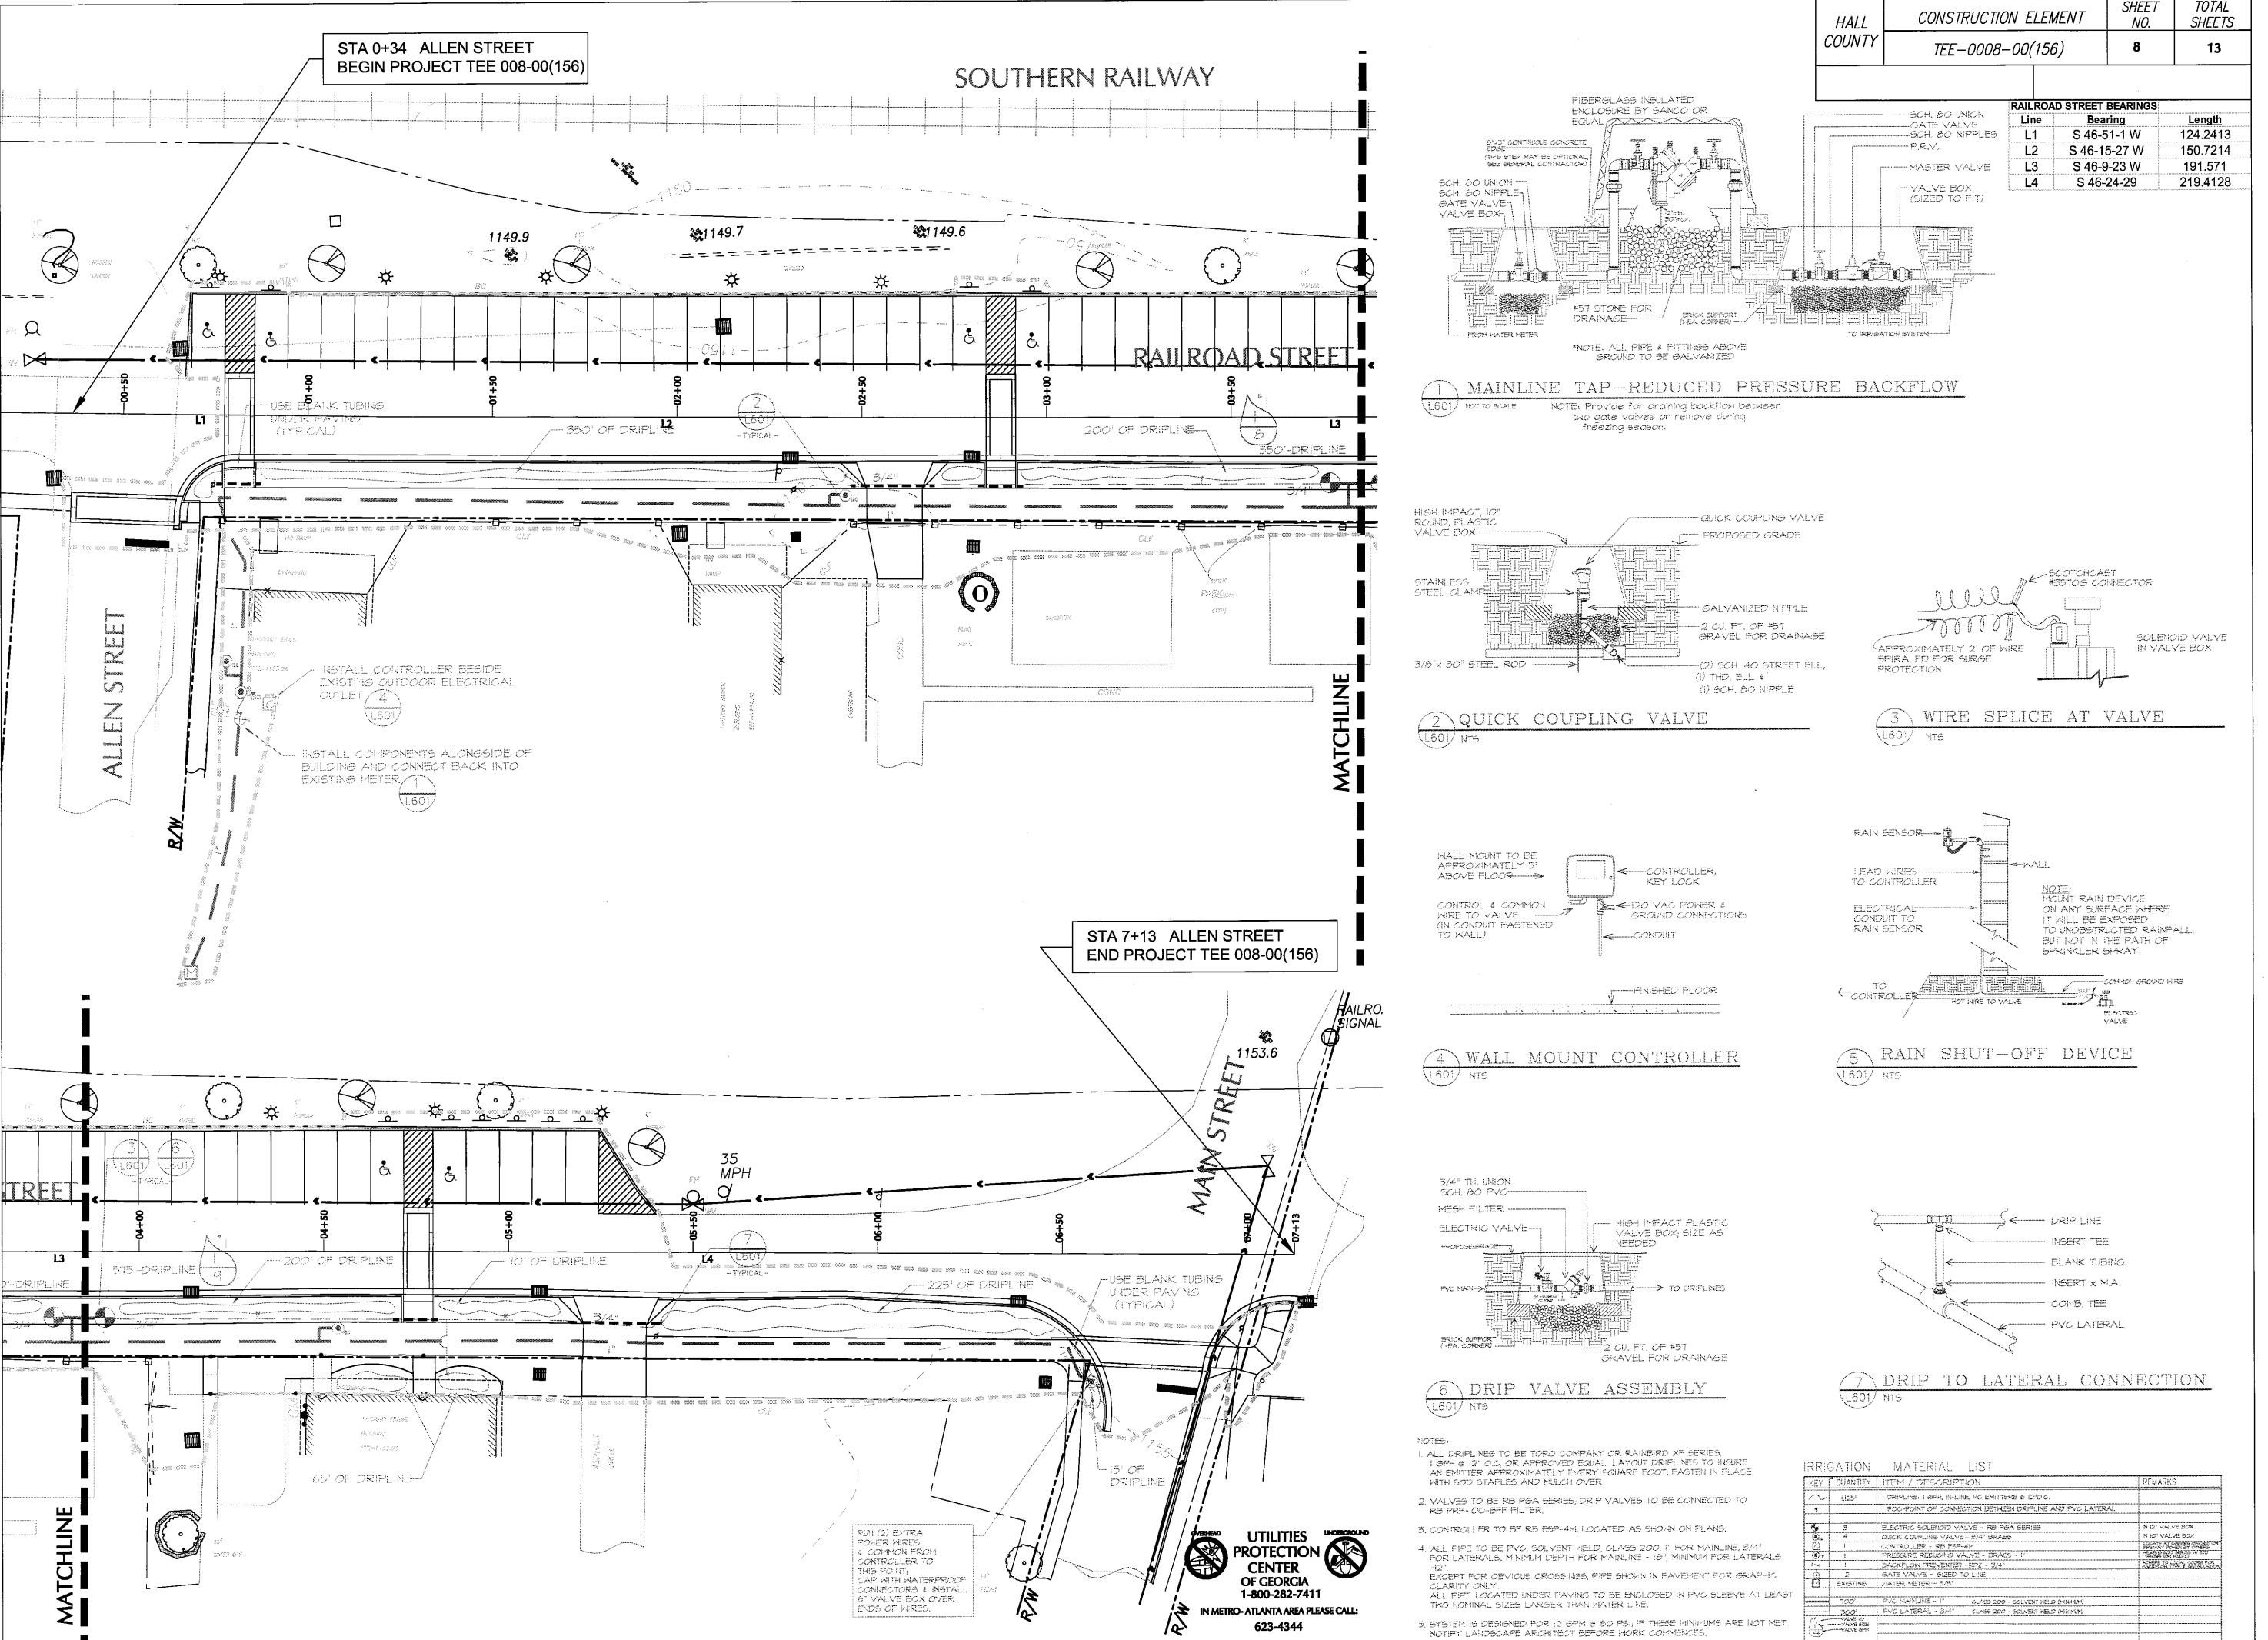

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ROJECT No. 0008156

RAILROAD STREET CORRIDOR IMPROVEMENT PROJECT PHASE I TEE-0008-00(156); PI No. 000815

Date:	1.31.08
Revisions	<u></u>
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ProjectNo	
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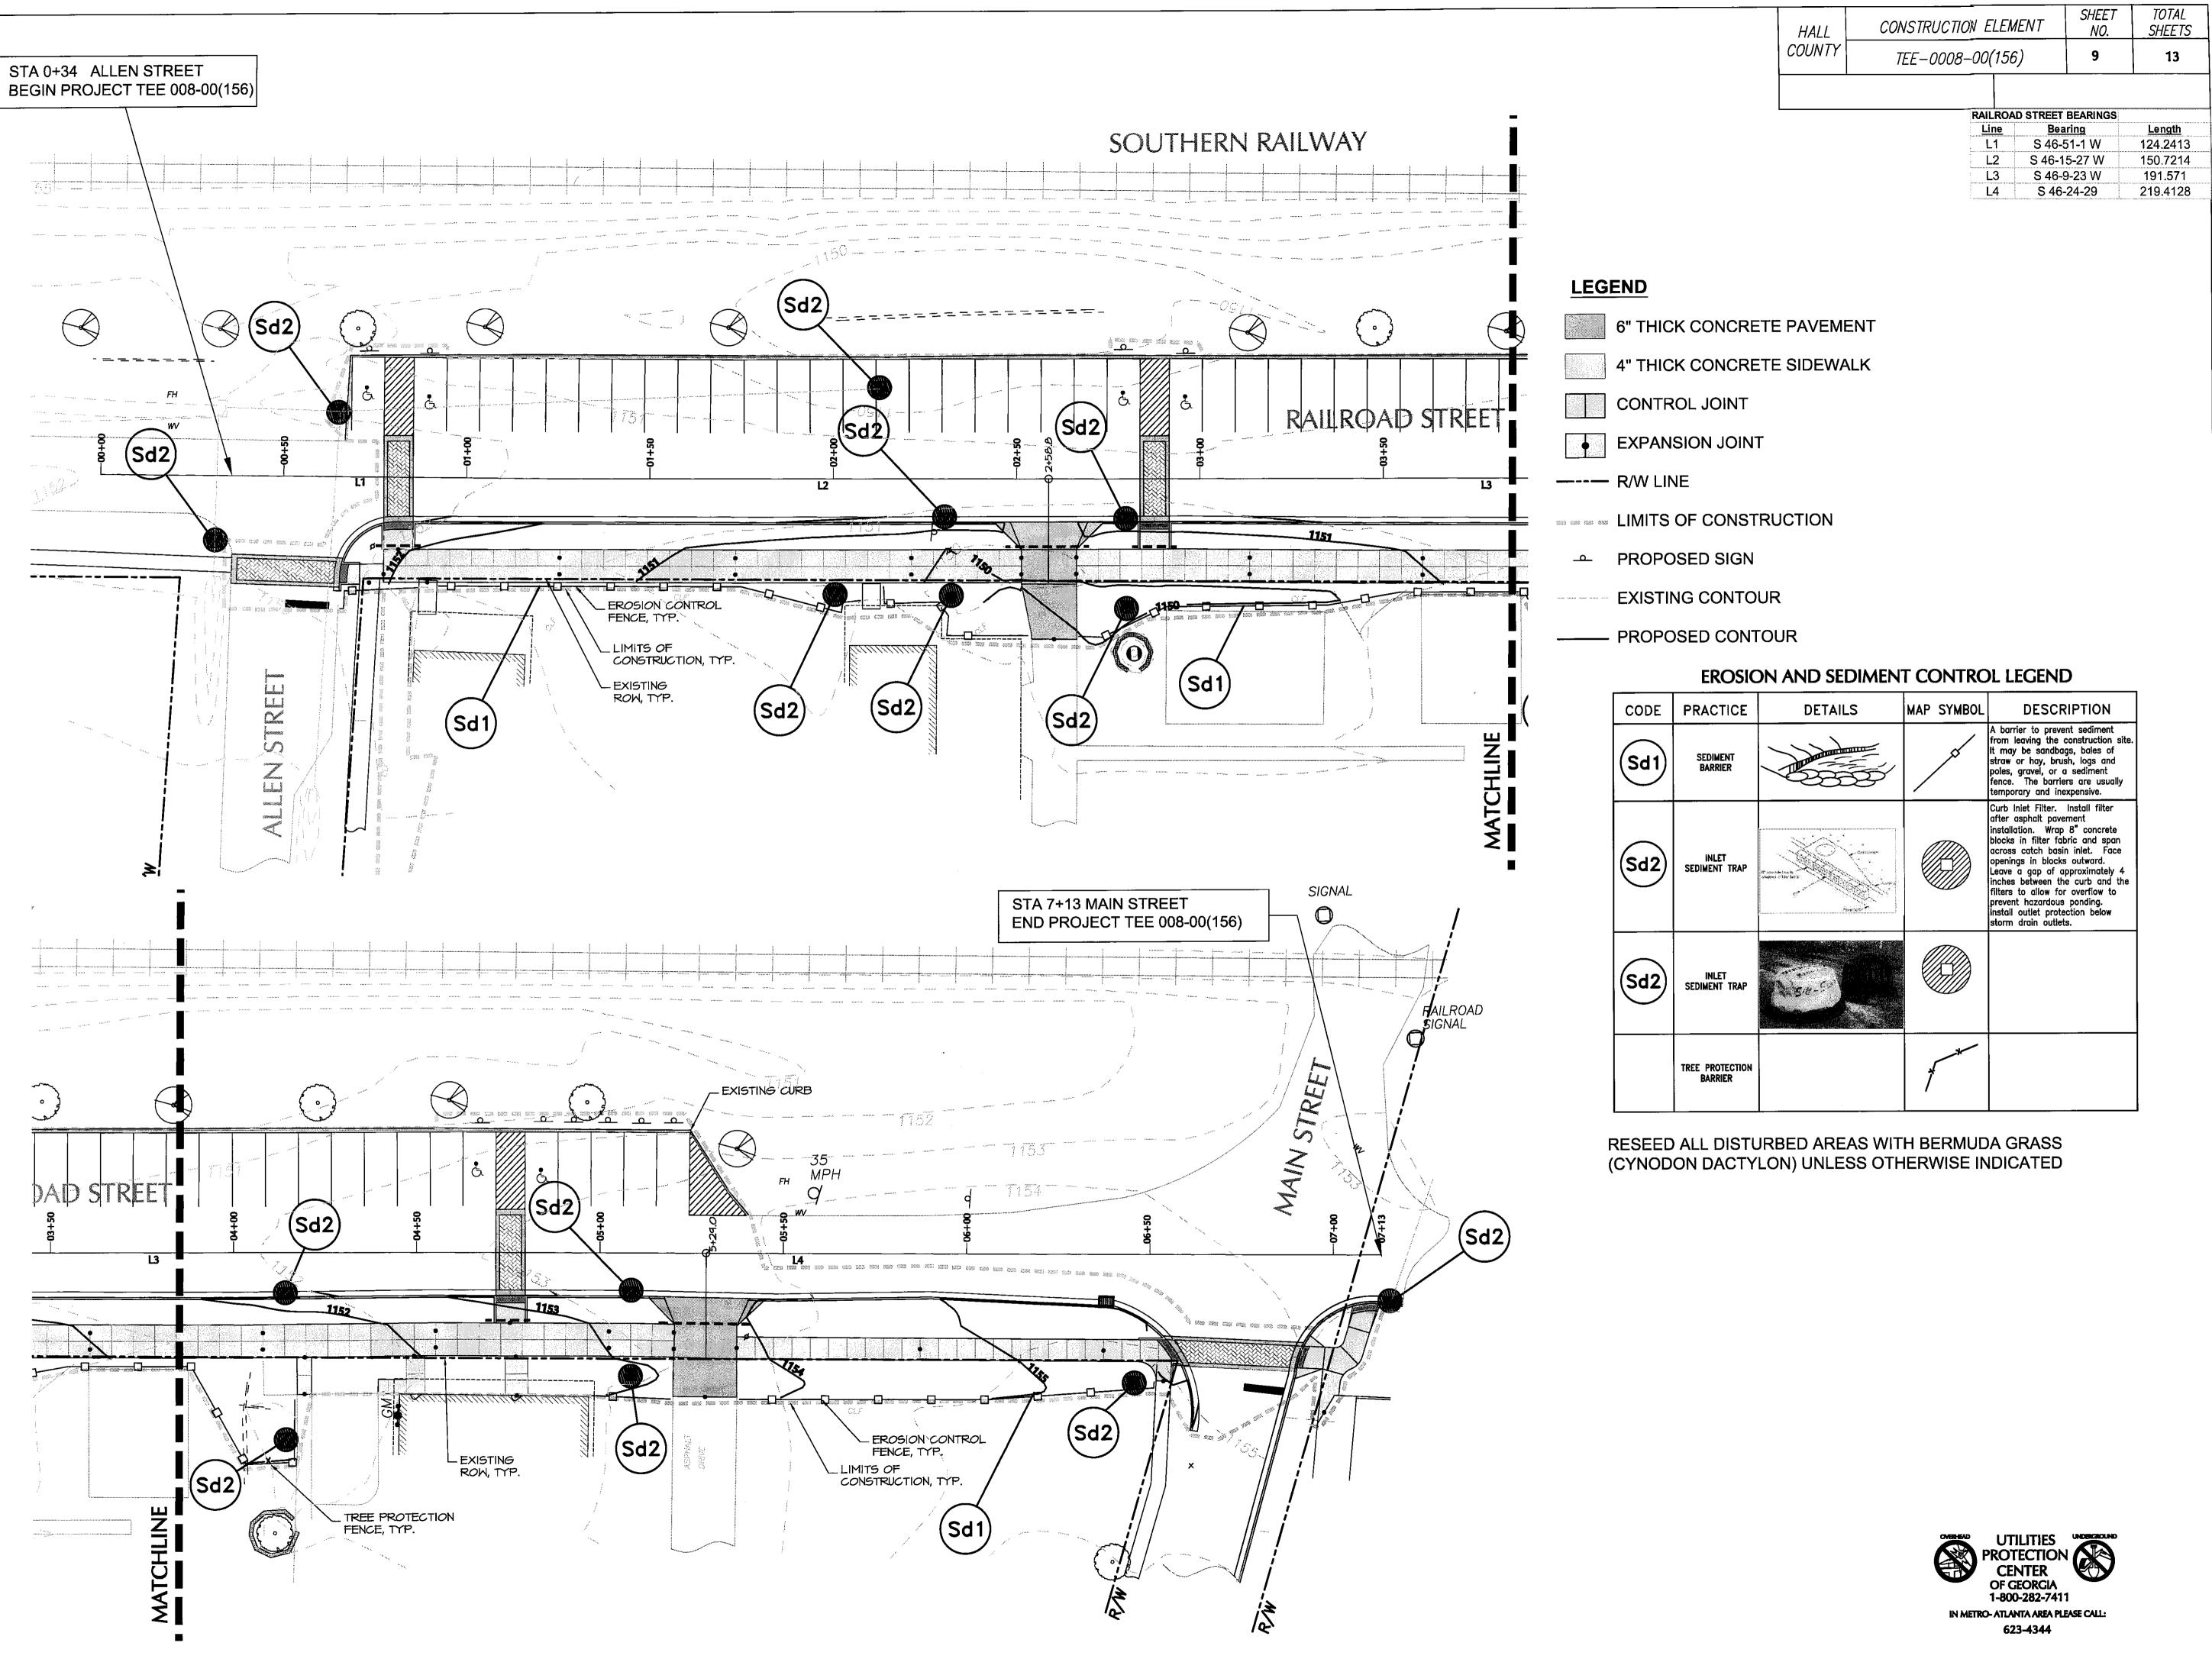




IRRIGATION PLAN

L.601

\*QUANTITIES FOR REFERENCE ONLY AND NOT FOR BIDDING PURPOSES.



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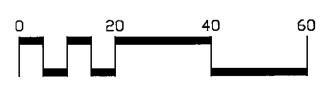


RAILROAD STREET CORRIDOR IMPROVEMENT PROJECT PHASE I TEE-0008-00(156); PI No. 0008156

CIT

Drawn: **CP** Checked: **SD,CT** 





EROSION &
SEDIMENT
CONTROL PLAN

EC.101

#### **ESPCP GENERAL NOTES:**

The escape of sediment from the site shall be prevented by the installation of erosion and sediment control measures and practices prior to, or concurrent with, land disturbing activities. Erosion control measures will be maintained at all times. If full implementation of the approved plan does not provide for effective erosion control, additional erosion and sediment control measures shall be implemented to control or treat the sediment source.

#### TEMPORARY MULCHING

EPD General Permit GAR 100002 requires "Any disturbed area left exposed for a period greater than 14 days shall be stabilized with mulch or temporary seeding." - The Department typically requires disturbed areas to be stabilized every 7 days. The construction documents, special provisions, or Specifications may require mulching more often than 7 days.

#### **VEGETATION AND PLANTING SCHEDULE**

All temporary and permanent vegetative practices including plant species, planting dates, seeding fertilizer, lime and mulching rates for this project can be found in section 700 of the current edition of the Department's specifications and other applicable contract documents, special provisions, or landscaping plans.

#### SEQUENCE OF MAJOR ACTIVITIES

The Contractor is responsible for developing the construction schedule for the project. The construction schedule for this project shall be submitted with the NOI. A copy of the construction schedule shall be maintained at the project site.

#### PLAN ALTERATIONS

The Erosion Sedimentation and Pollution Control Plan (ESPCP) is provided by the Department. If the Contractor elects to alter the stage construction from that shown in the plans, and the Engineer approves the request, it will be the responsibility of the contractor to revise the ESPCP to reflect all changes in stage construction. This will also include any revisions to erosion and sedimentation control item quantities.

Major modification or deletion of structural BMP's that are specified in the ESPCP will require a formal revision of the ESPCP and the signature of a GSWCC level-II-certified design professional. Additional BMP's may be added as directed by the Engineer.

#### PETROLEUM STORAGE, SPILLS AND LEAKS

The plans provided herein do not anticipate the storage of petroleum products onsite. The contractor

shall at a minimum provide and be able to produce the necessary provisions for the capture and disposal of any petroleum product leaks or spills associated with the servicing, refueling or operation of any equipment utilized in the work.

If the storage of petroleum products onsite is desired by the contractor the following is required; ESPCP Addendum prepared by a licensed design professional as required by GAR100002 for inclusion with these plans.

The contractor's attention is specifically directed to Standard Specification 107-Legal Regulations and Responsibility to the public for additional requirements.

### SOIL SERIES INFORMATION

A project specific soil survey was performed for this project. The NRCS soil survey and soil series

maps for the project area are available on the internet at: http://websoilsurvey.nrcs.usda.gov/app .

### POST-CONSTRUCTION BMP'S

All permanent, post-construction BMP's are shown in the construction plans and in the ESPCP plan. The post-construction BMP's for this project may consist of permanent vegetation, permanent slope drains and/or flumes, rip-rap at pipe outlets for velocity dissipation and outlet stabilization, vegetated swales/ditches where practical, channel/ditch stabilization with Turf Reinforcing Mats, rip-rap and concrete ditch lining where necessary. The post-construction BMP's will provide permanent stabilization of the site and prevent accelerated transportation of sediment and pollutants into receiving waters.

## SILT FENCE INSTALLATIONS WITH J-HOOKS AND SPURS

Silt fence should never be run continuously.. The silt fence should turn back into the fill or slope to create small pockets that trap silt and force stormwater to flow through the silt fence. This technique, or configuration, is commonly referred to as J-hooks or spurs. The J-hooks shall be utilized on all silt fences that are located around the perimeter of the project and along the toe of embankments or slopes. The J-hooks shall be spaced in accordance with the Typical Location Details for silt fences/baled straw. Spacing for J-hooks shall not be less than 50 feet except as noted. Silt fences that are near the outlet of culverts, cross drains, and storm drains shall have a minimum of three (3) J-Hooks on both sides of the structure at spacing not to exceed 30 feet. J-Hooks shall be paid for as silt fence items per foot. All costs and other incidental items are included in cost of installing and maintaining the silt fence.

### MAINTENANCE AND STABILIZATION MEASURES

See Special Provision 161 and 700 and other contract documents for maintenance and stabilization measures.

	The state of the s		
GDOT STANDARD DETAILS			
NUMBER	NAME	DATE REVISED	
D-20	INLET SEDIMENT TRAP	DECEMBER 2000	
D-24A	TEMPORARY SILT FENCE, BALED STRAW EROSION CHECK, BRUSH BARRIER DETAILS	SEPTEMBER 2001	
EC-L1-L6	EROSION CONTROL LEGEND AND UNIFORM CODE SHEET	JANUARY 2007	

#### WASTE DISPOSAL

Solid materials, including building materials, shall not be discharged to Waters of the State, unless authorized by a Section 404 Permit.

#### INSPECTIONS

All inspections shall be documented on the appropriate Department inspection forms. See Special Provision 167 and other contract documents for inspection requirements. These inspections shall continue until the Notice of Termination (NOT) is submitted. Failure to perform inspections as required by the contract documents and the NPDES permit shall result in the cessation of all construction activities with the exception of Traffic Control and Erosion Control. Continued failure to perform inspections shall result in non-refundable deductions as specified in the contract documents.

#### NON-STORM WATER DISCHARGES

Non-storm water discharges defined in Part III.A.2 of the NPDES Permit will be identified after construction has commenced. These discharges shall be subject to the same requirements as storm water discharges required by the Georgia Erosion and Sedimentation Control Act, the NPDES Permit, the Clean Water Act, the Manual For Erosion and Sediment Control in Georgia, Department Standards, and contract documents.

#### **DE-WATERING ACTIVITIES AND USE OF PUMPS**

Any pumped discharge from an excavation shall be routed through a sediment basin or shall be treated equivalently with suitable BMP's.

### OTHER CONTROLS

The contractor shall follow this ESPCP and ensure and demonstrate compliance with applicable State and/or local waste disposal, sanitary sewer or septic system regulations.

The contractor shall control dust from the site in accordance with Section 161 of the current edition of the Department's Specifications.

#### SEDIMENT BASINS

Sediment basins will be utilized at all outfall locations except as noted below:

Station(s) \_\_\_\_\_\_\_: A Sediment Basin(s) is (are) not used at this (these) location(s). The disturbed acreage within the drainage area is \_\_\_\_\_\_. The disturbance activities consist

of\_\_\_\_\_\_\_. BMP's as shown on the erosion control plans will be adequate to control sediment runoff at this (these) location(s). Land disturbance activities associated with constructing and removing a sediment basin at this (these) location(s) would cause additional adverse impacts.

#### STREAM BUFFER ENCROACHMENT

Stream Buffers (are/are not) impacted by this project.

## REVISED OCTOBER 2007

HALL	CONSTRUCTION ELEMENT	SHEET NO.	TOTAL SHEETS
COUNTY	TEE-0008-00(156)	10	13

### **GENERAL GRADING NOTES**

- CONTRACTOR SHALL LOCATE ALL UTILITIES BEFORE WORK SHALL BEGIN. UTILITY LOCATIONS SHOWN HEREIN ARE APPROXIMATE. ALL UTILITIES MAY NOT BE SHOWN.
- 2. CONTRACTOR SHALL GRADE ALL DISTURBED AREAS TO ENSURE POSITIVE DRAINAGE TO DRAINAGE STRUCTURES AND DITCHES. NATURAL FLOW OF SURROUNDING WATERS SHALL NOT BE DISTURBED DURING CONSTRUCTION.
- 3. ALL EARTHWORK OPERATIONS REQUIRED FOR CONSTRUCTION OF THE VARIOUS STRUCTURES AND UTILITY LINES INDICATED SHALL BE CONDUCTED IN ACCORDANCE WITH THE APPLICABLE PROVISIONS OF THE SPECIFICATIONS. GRADING SHALL BE AS INDICATED, AND SHALL PRODUCE A FINISHED SURFACE WITH NO PONDING OF WATER, READY TO RECEIVE PAVING. PLANTING MATERIALS OR GRASSING.
- ALL TOPSOIL AND EXCAVATED MATERIAL SHALL BE STOCKPILED IN AN APPROVED AREA DURING CONSTRUCTION. EXCESS OR UNUSABLE TOPSOIL SHALL BE DISPOSED OF OFF SITE. EXCAVATED MATERIAL TO BE STORED AT AN APPROVED LOCATION.
- THE CONTRACTOR SHALL PROPERLY DISPLAY THE LAND DISTURBANCE
  PERMIT ON THE SITE AT ALL TIMES DURING CONSTRUCTION AND IN PLAIN VIEW
  FROM THE THOROUGHFARE.
- 6. CONTRACTOR SHALL INCORPORATE BMP'S PRIOR TO ANY DEMOLITION WORK. ANY DAMAGE TO THE NATURAL RESOURCES SHALL BE REPLACED BACK TO ITS ORIGINAL STATE AT THE CONTRACTOR'S EXPENSE.
- 7. PROPOSED CURBS TO TIE IN TO EXISTING CURBS, UNLESS NOTED OTHERWISE.
- 8. CONTRACTOR SHALL ADJUST TOP OF EXISTING SANITARY SEWER MANHOLES AND UTILITY BOXES TO MATCH FLUSH WITH PROPOSED GRADES AS NECESSARY.
- 9. PROPOSED SIDEWALK SHALL MATCH EXISTING ELEVATION AT BUILDING FACE, UNLESS NOTED OTHERWISE.
- 0. MAINTAIN POSITIVE DRAINAGE FROM FACE OF BUILDING TO CURB.

THE
JAEGER

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COMPANY

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RAILROAD STREET CORRIDOR IMPROVEMENT PROJECT PHASE I EE-0008-00(156); PI No. 0008156

Date: **1.31.08** 

ProjectNo.: **07002** 

Checked: SD,CT

Drawn: CP

Ğ.

"I certify that this Erosion, Sedimentation and Pollution Control Plan has been prepared in accordance with part IV GAR 100002."

"I certify under penalty of law that this document and all attachments were prepared under my direction or supervision in accordance with a system designed to assure that the qualified personnel properly gather and evaluate the information submitted. Based on my inquiry of the person or persons who manage the system, or those persons directly responsible for gathering the information, the information submitted is, to the best of my knowledge and belief, true, accurate, and complete. I am aware that there are significant penalties for submitting false information, including the possibility of fine and imprisonment for knowing violations."

I certify under penalty of law that this plan was prepared after a site visit to the location described herein by myself or my authorized agent under my direct supervision.


Dale JAEGER DALE

<u>3-11-08</u> DATE

LEVEL 2 CERTIFIED DESIGN PROFESSIONAL # 0000041297

EROSION &
SEDIMENT
CONTROL NOTES
AND DETAILS

EC.102

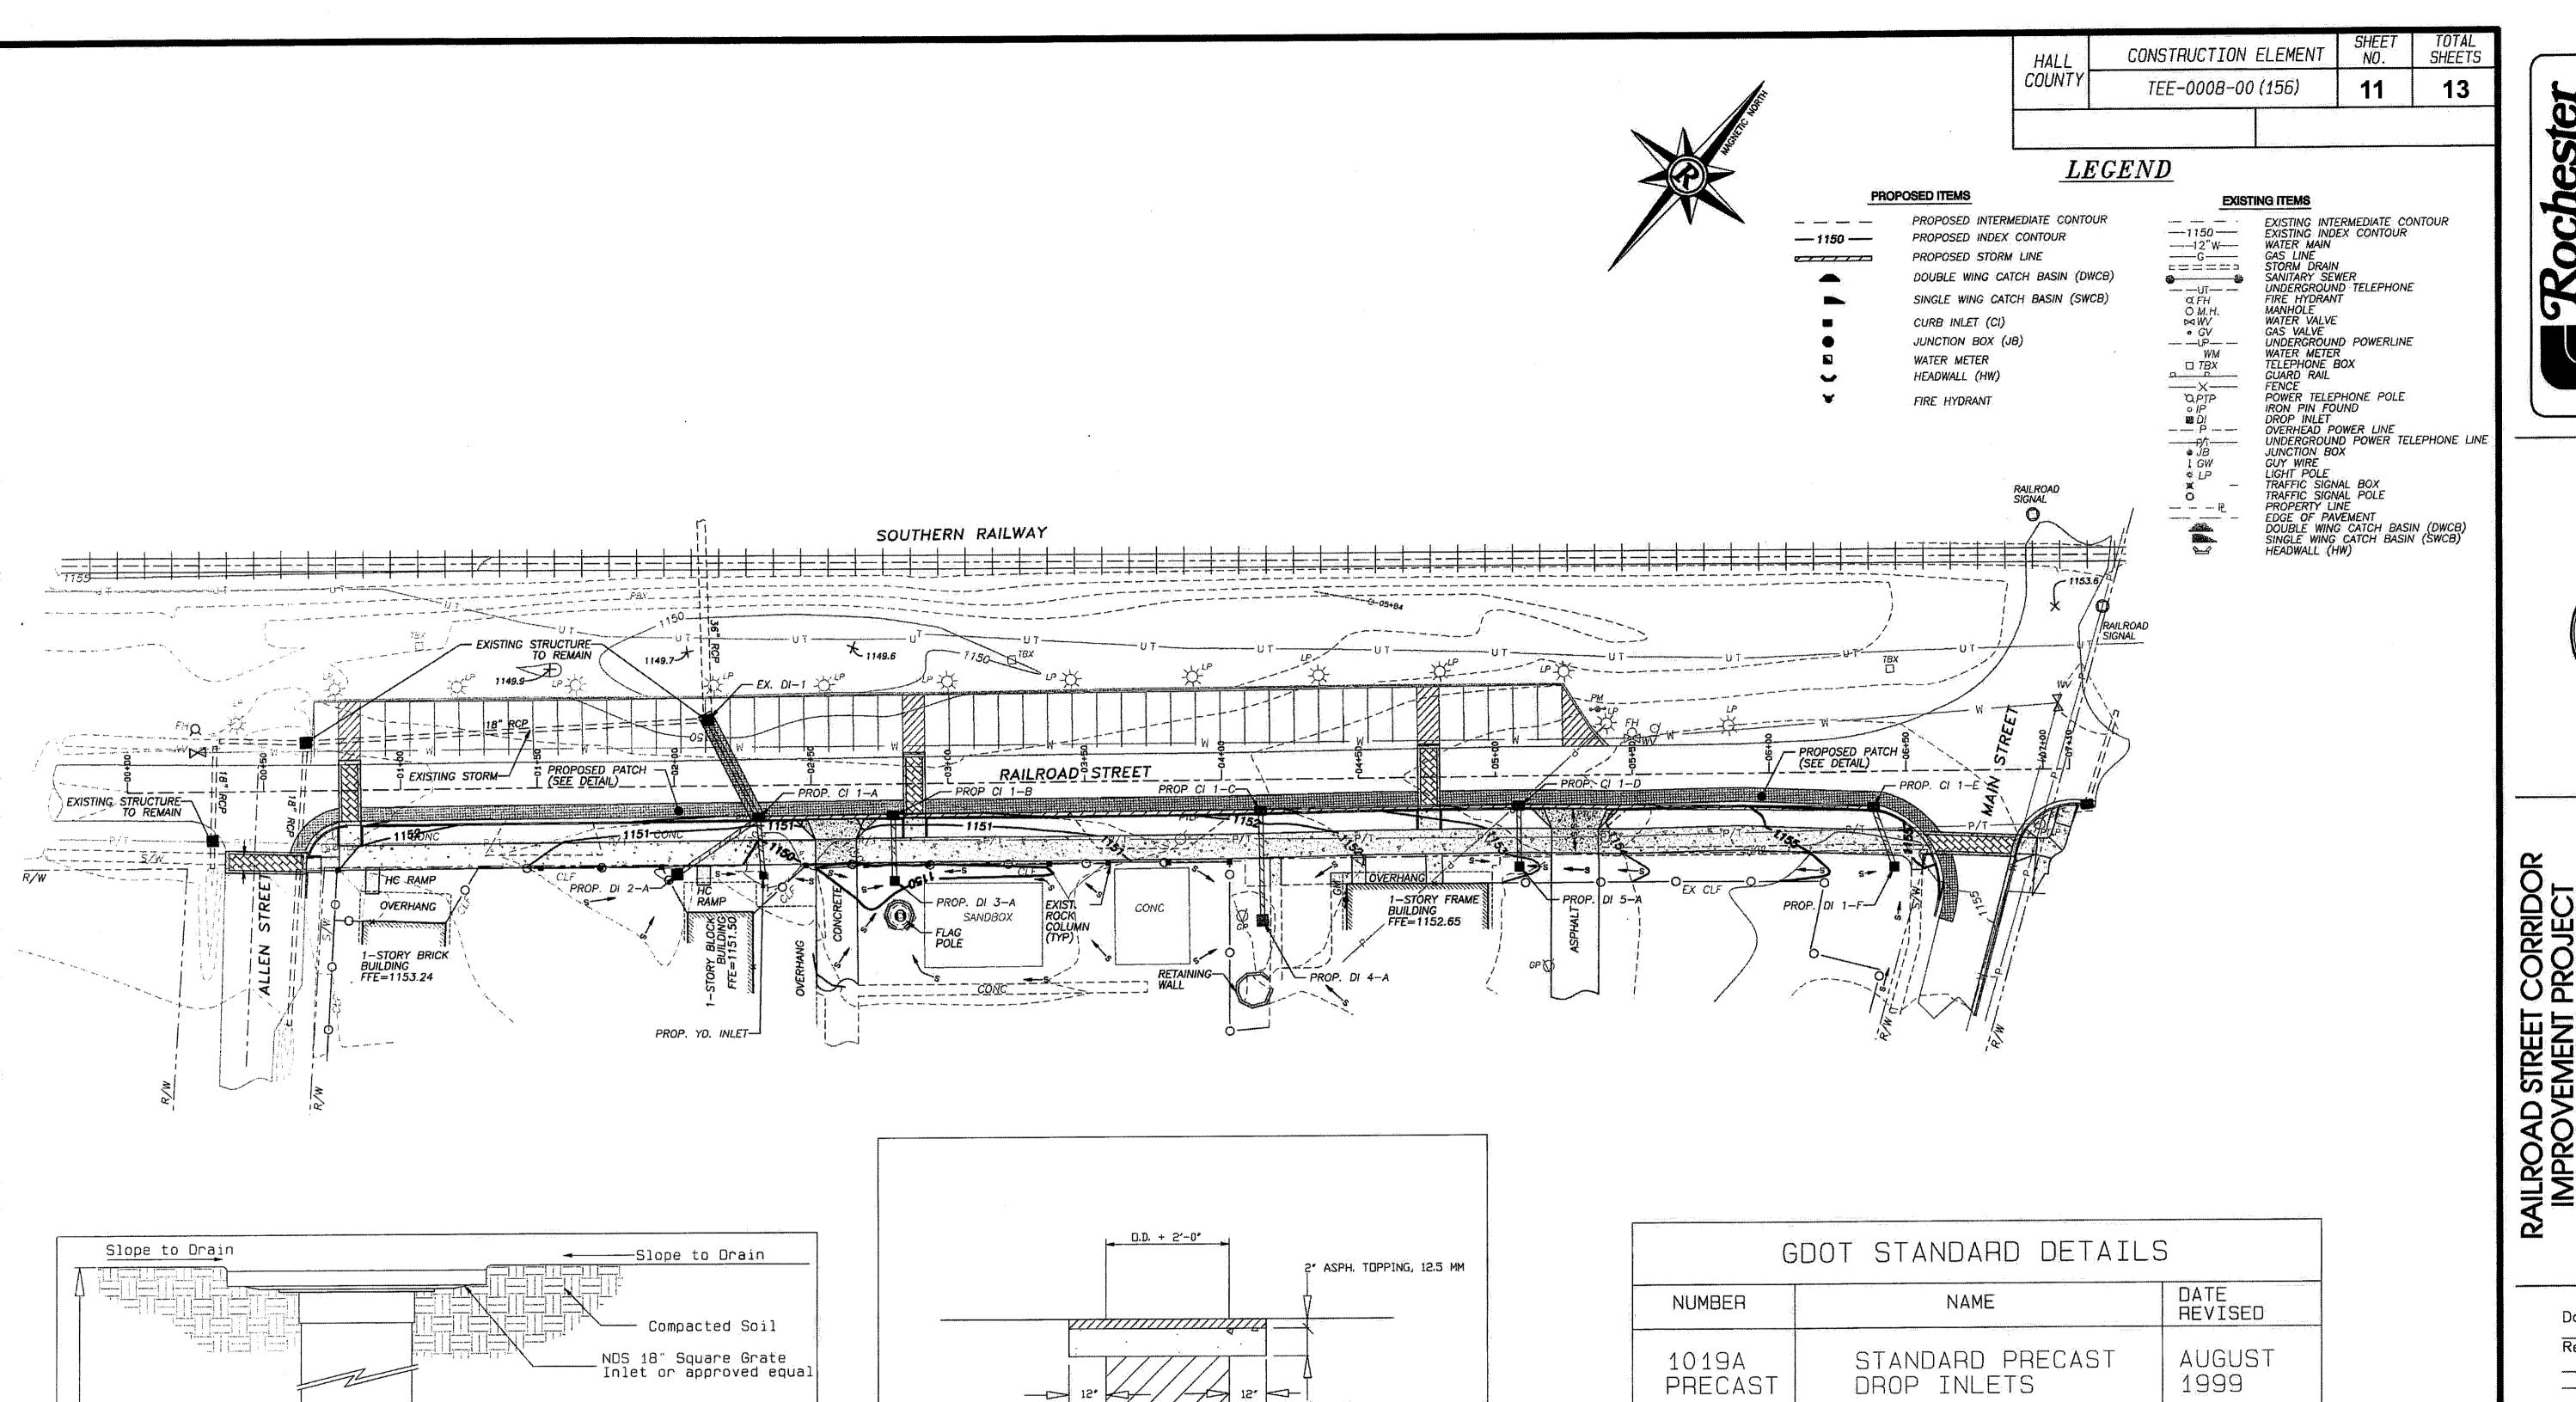

8° MIN., I.D. ≤ 21° 12° MIN., I.D. ≤ 24°

PAVEMENT PATCH AND PIPE BEDDING DETAIL


NOTE: PAVEMENT REPLACEMENT SHALL MATCH EXISTING THICKNESS IF MORE THAN SHOWN IN THIS DETAIL.

-6" Crushed Stone

YARD INLET DETAIL

NOT TO SCALE

2' ASPH. TOPPING, 12.5 MM	GDOT STANDARD DETAILS		
	NUMBER	NAME	DATE REVISED
15.	1019A PRECAST	STANDARD PRECAST DROP INLETS	AUGUST 1999
BACKFILL TO BE TAMPED IN 6* LAYERS  8" CONC.  0.25×0.D.  4" MIN.	1019A	STANDARD DROP INLETS	AUGUST 1999
#57 STONE			

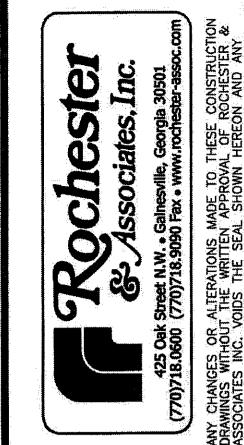



RAILROAD STREET CORRIDOR IMPROVEMENT PROJECT PHASE I TEE-0008-00(156); PI No. 0008156

ProjectNo.: <u>07002</u> Scale: <u>SCALE: 1" = 30'</u> Drawn: RBW

Checked: **JNC** 

GRADING DRAINAGE

C.01

GRAPHIC SCALE

